



KWIK TRIP

**STORES** 



# **STORES**


KWIK TRIP, Inc. P.O. BOX 2107 1626 OAK STREET LA CROSSE, WI 54602-2107 PH. (608) 781-8988 FAX (608) 781-8960



REI Engineering, INC. 4080 N. 20TH AYENUE YIAUSAU, WISCONSIN 54401 PHONE: 15,675,9784 FAX. 715,675,4060 EMAIL: MAIL®REIENGINEERING.COM

CONVENIENCE STORE PLAN DEMO I

DEMO PL	CONVENIENCE	WEBSTER AVENUE ALLOUEZ, WI
# DATE		CRIPTION
<u> </u>	<u> </u>	
DRAWN BY		NAP
SCALE		GRAPHIC
PROJ. NO.		7076A
DATE		10/14/15 - BID DOCS
SHEET		SP

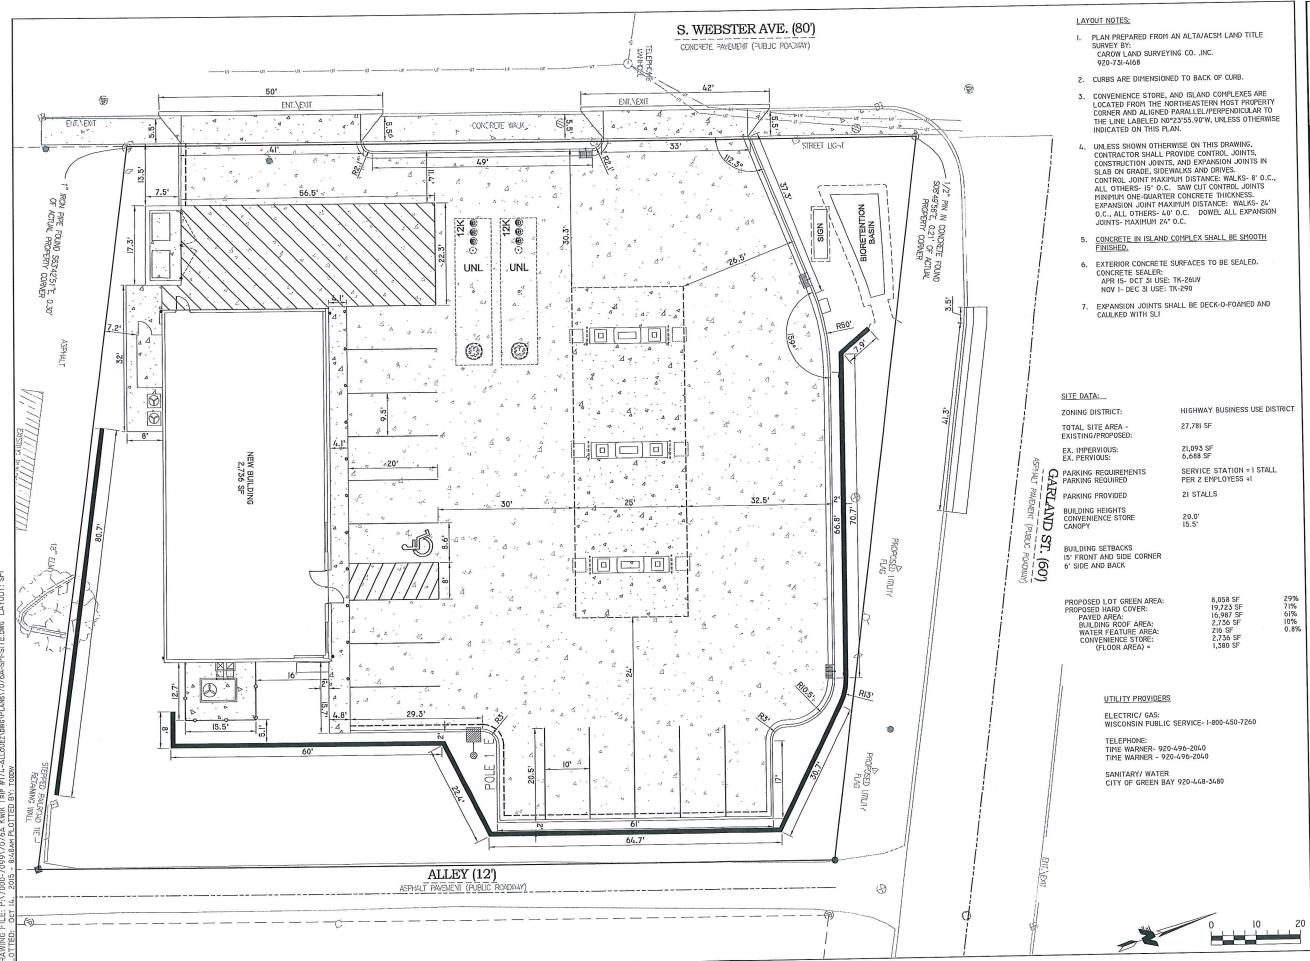






KWIK TRIP, Inc. P.O. BOX 2107 1626 OAK STREET LA CROSSE, WI 54602-2107 PH. (608) 781-8988 FAX (608) 781-8960



SITE PLAN
SONVENIENCE STORE
VEBSTER AVENUE
ALLOUEZ, WI

# DATE	DESCRIPTION
<u> xx/xx</u>	/XX
DRAWN BY	NAP
DRAWN BY SCALE	NAP GRAPHIC
SCALE	GRAPHIC

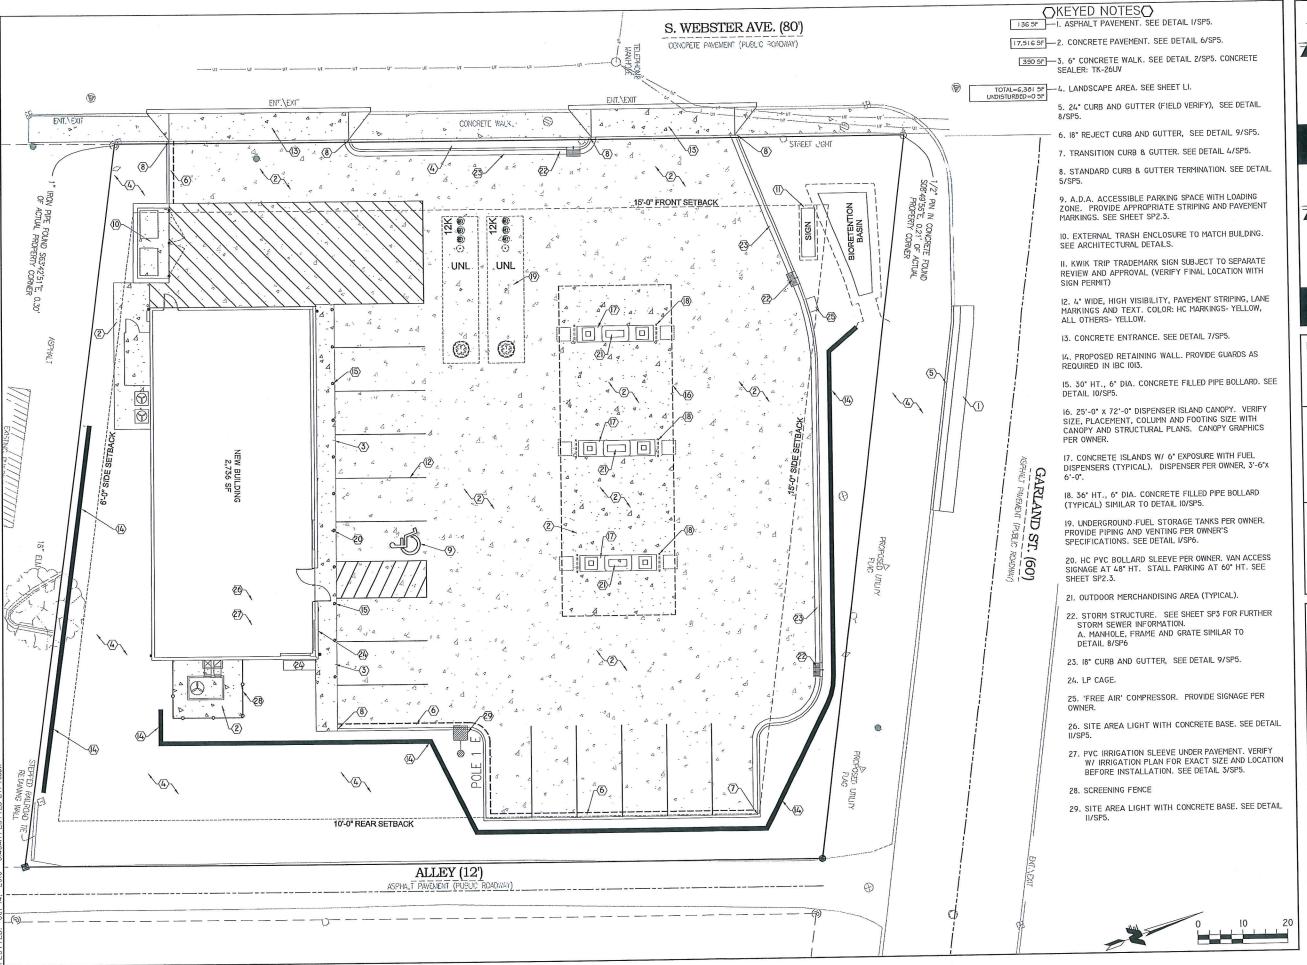



KWIK TRIP, Inc. P.O. BOX 2107 1626 OAK STREET LA CROSSE, WI 54602-2107 PH. (608) 781-8988 FAX (608) 781-8960




EMAIL: MAIL@REIENGINEERING.COM

# ITE PLAN (KEYNOTES)

WEBSTER AVENUE ALLOUEZ, WI

SIT	CO	WEB
# DATE	DESCRI	PTION
DRAWN BY		NAP
SCALE	G	BRAPHIC
PROJ. NO.		7076A
DATE	1	0/14/15 - BID DOCS
SHEET		SP1.1

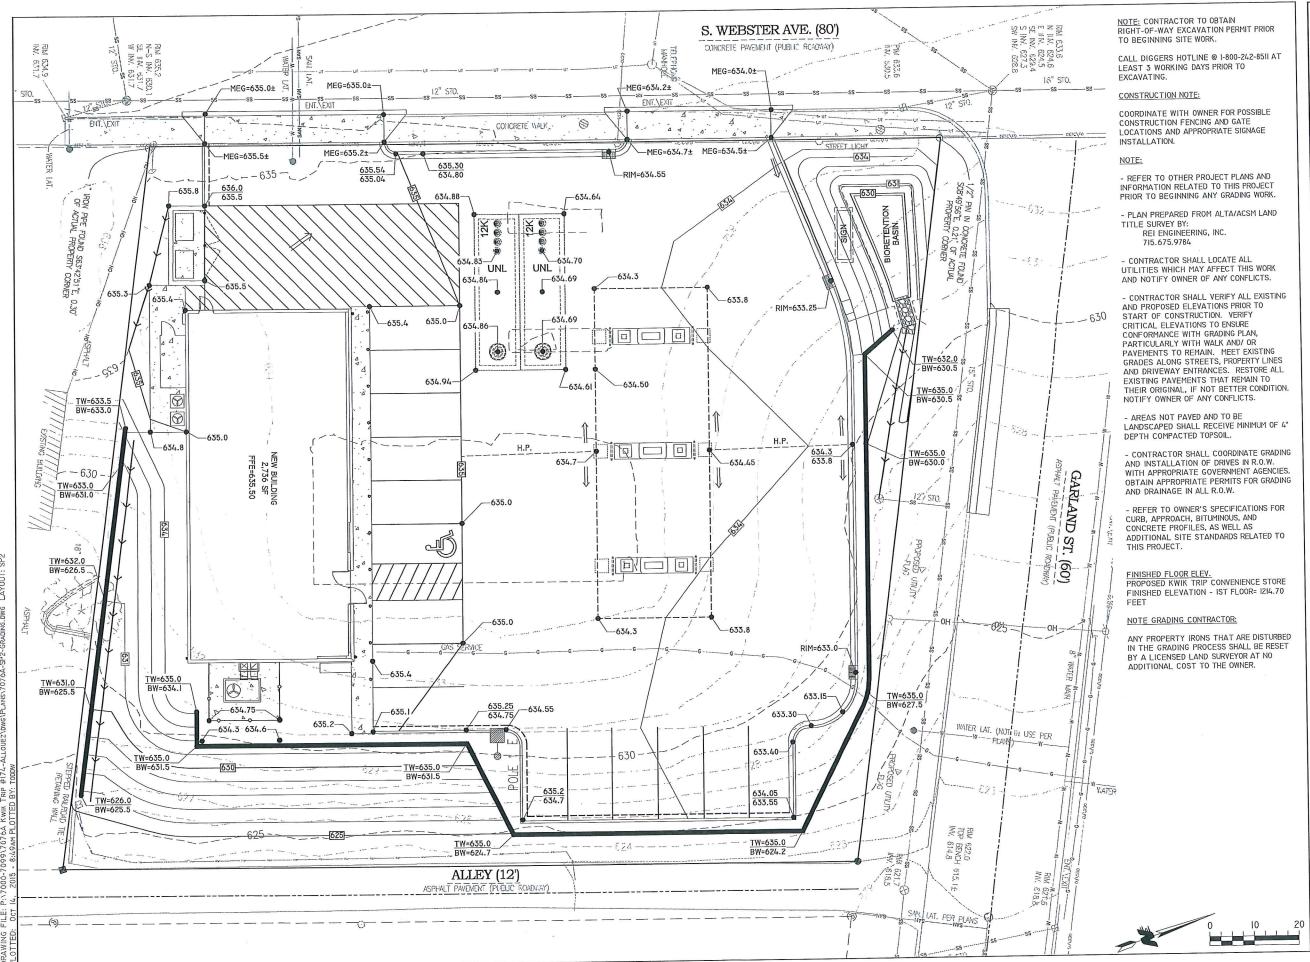

KWIK TRIP

STORES



# **STORES**

KWIK TRIP, Inc. P.O. BOX 2107 1626 OAK STREET LA CROSSE, WI 54602-2107 PH. (608) 781-8988

FAX (608) 781-8960


CIVIL & ENVIRONMENTAL ENGINEERING, SURVEYING

REI Engineering, INC. 4080 N. 20TH AYENSE WALISAU, WISCONSIN 54401 PHONE: 715.675.9784 FAZ 715.675.4060 EMAIL: MAIL@REIENGINEERING.COH

GRADE PLAN ONVENIENCE STORE

GR	CONVEN	WEBSTER, ALLOUEZ, \
# DATE		CRIPTION
DRAWN BY		DDD
SCALE		GRAPHIC
PROJ. NO.		7076A
DATE		10/14/15 - BID DOCS
SHEET		SP2

AVENUE

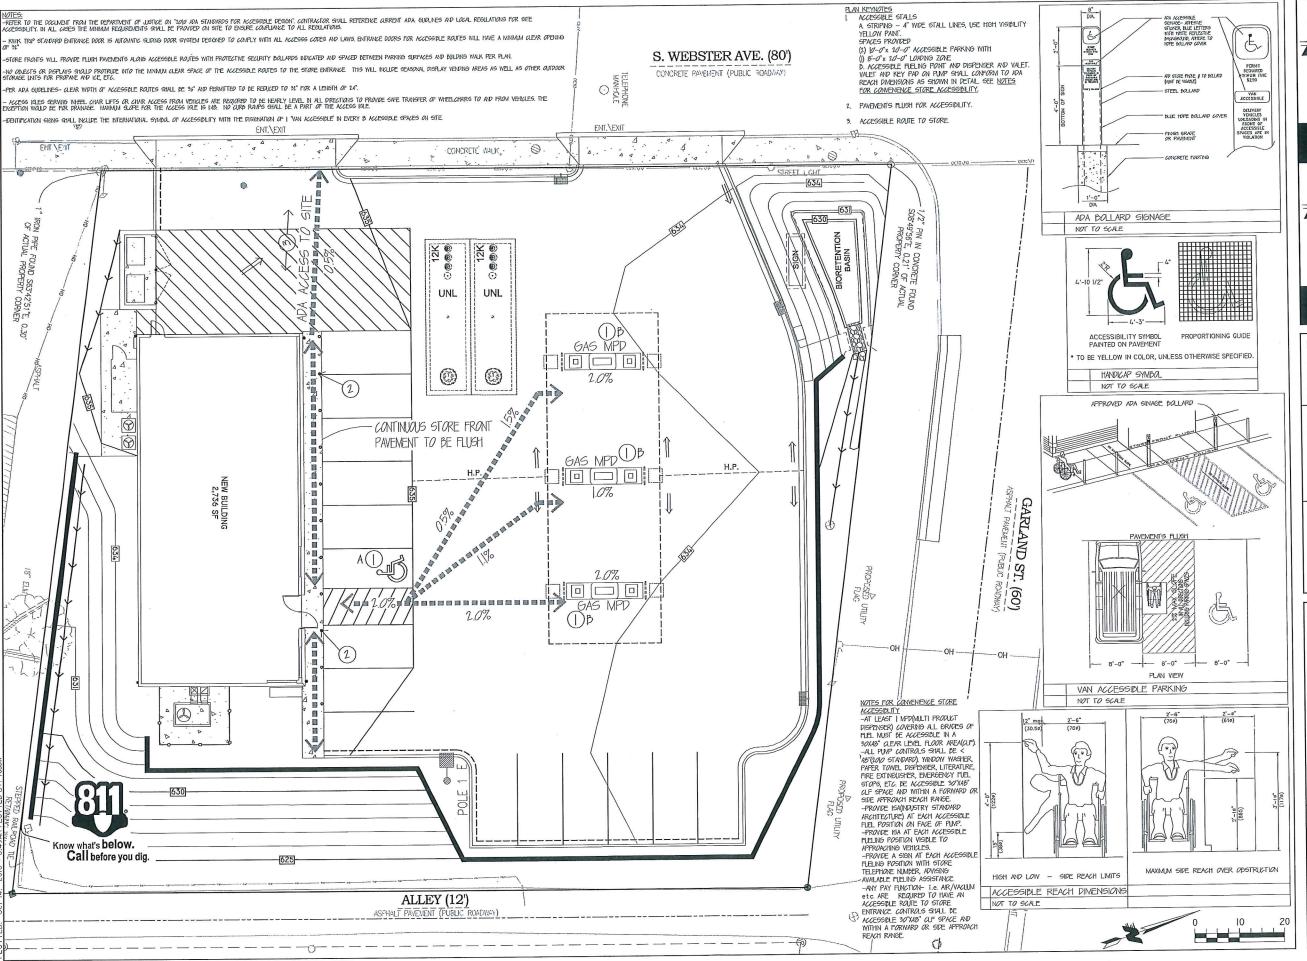




KWIK TRIP, Inc. P.O. BOX 2107 1626 OAK STREET LA CROSSE, WI 54602-2107 PH. (608) 781-8988 FAX (608) 781-8960



REI Engineering, INC.
4080 N. 2011 AVENUE
WALSAU, WISCONSIN 54401
FHONE: 715.675.9784 FAX: 715.675.4060
EMAIL: MAIL-GREIENGINEERING.COM

# ACCESSIBLE PLAN CONVENIENCE STORE WEBSTER AVENUE ALLOUEZ, WI

1	
# DATE	DESCRIPTION
<u>XX/XX/XX</u>	-
	-
DRAWN BY	DDD
SCALE	GRAPHIC
PROJ. NO.	7076A
DATE	10/14/15 - BID DOCS
SHEET	SP2.3

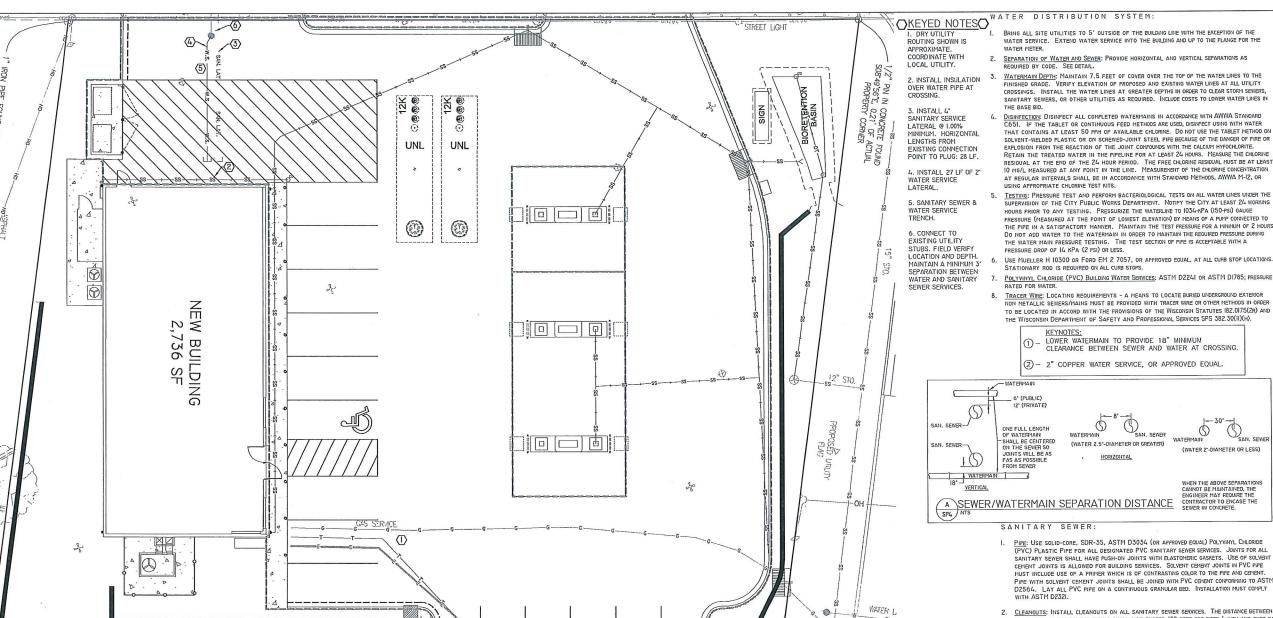

COMPLY WITH THE WORK SAFETY FRACTICES SPECIFIED BY THE OCCUPATIONAL SAFETY AND HEALTH ADMINISTRATION (OSHA). COMPLY WITH ALL APPLICABLE LOCAL, STATE, AND FEDERAL SAFETY REGULATIONS. OSHA PROHBITS ENTRY INTO "CONFINED SPACES," SUCH AS MANHOLES AND INLETS (SEE 29 CFR SECTION 1910.146), WITHOUT UNDERTAKING CERTAIN SPECIFIC PRACTICES AND PROCEDURES. CONSTRUCTION SAFETY IS SOLD Y THE RESPONSIBILITY OF THE CONTRACTOR, WHO IS ALSO SOLELY RESPONSIBLE FOR THE MEANS, METHODS, AND SEQUENCING OF THE

EXISTING BOUNDARY, LOCATION, TOPOGRAPHIC, AND UTILITY INFORMATION SHOWN ON THIS PLAN IS FROM A FIELD SURVEY BY REI ENGINEERING, INC. DATED SEPTEMBER 9TH, 2014.

PERFORM ALL UTILITY WORK IN ACCORDANCE WITH STATE AND CITY REQUIREMENTS.

ENERAL:

CONNECT TO EXISTING SANITARY SEWER MH'S BY COREDRILLING. CONNECT TO EXISTING STORM SEWER MH'S BY EITHER SAWCUTTING OR COREDRILLING. USE SAWS OR DRILLS THAT PROVIDE WATER TO THE BLADE. MEET ALL CITY II. WHERE EXISTING GAS, ELECTRIC, CABLE, OR TELEPHONE UTILITIES CONFLICT WITH THE WORK, COORDINATE THE STANDARDS AND SPECIFICATIONS FOR THE THE CONSCIPLING. SCONSTRUCT INVESTS AFTER INSTALLATION. USE WATER STOP GASKETS IN ORDER TO PROVIDE WATERTIGHT SEALS WHEN PERETRATING A STRUCTURE WALL WITH A P.P.E. TAKE MEASUREMENTS BEFORE BEGINNING CONSTRUCTION TO ENSURE THAT SERVICE CONNECTIONS DO NOT CUT INTO MAINTENANCE ACCESS STRUCTURE JOINTS OR PIPE BARREL JOINTS

PART 1926, SUBPART P. "EXCAVATIONS AND TRENCHES." (WWW.DSHA.GOV)

COORDINATE BUILDING UTILITY CONNECTION LOCATIONS AT 5 FT. OUT FROM THE FROPOSED BUILDING WITH THE WITH THE INTERIOR PLUMBING CONTRACTOR PRIOR TO CONSTRUCTION. VERIFY WATER AND SEVER SERVICE LOCATIONS AND ELEVATIONS WITH THE MECHANICAL ENGINEER PRIOR TO CONSTRUCTION.

THE SUBSURFACE UTILITY INFORMATION SHOWN ON THIS PLAN IS UTILITY QUALITY LEVEL D. THIS QUALITY LEVEL WAS DETERMINED ACCORDING TO THE GUIDELINES OF CITASCE 38-02, ENTITLED "STANDARD GUIDELINES FOR THE COLLECTION AND DEPICTION OF EXISTING SUBSURFACE UTILITY DATA."

THE LOCATIONS OF EXISTING UTILITIES SHOWN ON THIS PLAN ARE FROM RECORD INFORMATION. THE ENGINEER DOES NOT GUARANTEE THAT ALL EXISTING UTILITIES ARE SHOWN OR, IF SHOWN, EXIST IN THE LOCATIONS INDICATED ON THE PLAIL. IT IS THE CONTRACTOR'S RESPONSIBILITY TO ASCERTAIN THE FIVAL VERTICAL AND HORIZONTAL LOCATION OF 14. RELOCATE OVERHEAD POWER, TELEPHONE, AND CABLE LINES AS REQUIRED. ALL EXISTING UTILITIES (INCLUDING WATER AND SEWER LINES AND AFFURTENANCES). NOTIFY THE ENGINEER OF AN

 CONTACT UTILITY COMPANIES FOR LOCATIONS OF ALL PUBLIC AND PRIVATE UTILITIES WITHIN THE WORK AREA FRIOR TO BEGINNING CONSTRUCTION. CONTACT DIGGER'S HOTLINE AT (4/4) 259-II8I IN THE MILWAUKEE METRO AREA, OR I-800-242-85II ELSEWHERE IN WISCONSIN FOR EXACT LOCATIONS OF EXISTING UTILITIES AT LEAST 72 HOURS (NOT INCLUDING WEFKENDS AND HOLIDAYS) BEFORE BEGINNING ANY CONSTRUCTION. OBTAIN TICKET NUMBER AND MEET WITH 16. INCLUDING WEERENGS AND HOLDING'S DEFORE BEGINNING ART CORTINATION. OS DAMN TICKET MOVERS AND THEE! WI REPRESENTATIVES OF THE VARIOUS UTILITIES AT THE SITE. PROVIDE THE OWNER WITH THE TICKET KNIBEST INFORMATION. DIGGER'S HOTLINE IS A FREE SERVICE THAT LOCATES MUNICIPAL AND UTILITY COMPANY LINES, BUT DOES NOT LOCATE PRIVATE UTILITY LINES. USE AN INDEPENDENT LOCATOR SERVICE OR OTHER MEANS IN ORDER TO OBTAIN LOCATIONS OF FRIVATE UTILITY LINES INCLUDING, BUT NOT LIMITED TO, UNDERGROUND ELECTRIC CABLES, TELEPHONE, TV. AND LAWN SPRINKLER LINES.

10. POTHOLE TO VERIFY THE POSITIONS OF EXISTING UNDERGROUND FACILITIES AT A SUFFICIENT NUMBER OF LOCATIONS IN ORDER TO ASSURE THAT NO CONFLICT WITH THE PROPOSED WORK EXISTS AND THAT SUFFICIENT CLEARANCE IS AVAILABLE.

ABANDONMENT, RELOCATION, OFFSET, OR SUFFORT OF THE EXISTING UTILITIES WITH THE APPROPRIATE LOCAL UTILITY 19 COMPANIES. COORDINATE NEW GAS METER AND GAS LINE INSTALLATION, ELECTRIC METER AND ELECTRIC SERVICE INSTALLATION, CABLE SERVICE, AND TELEPHONE SERVICE INSTALLATION WITH THE LOCAL UTILITY COMPANIES.

PERFORM TRENCH EXCAVATIONS FOR ALL UTILITIES IN ACCORDANCE WITH THE REQUIREMENTS OF O.S.H.A. 29 CFR, 12. ARRANGE FOR AND SECURE SUITABLE DISPOSAL AREAS OFF-SITE. DISPOSE OF ALL EXCESS SOIL, WASTE MATERIA DEBNIS, AND ALL MATERIALS NOT DESIGNATED FOR SALVAGE. WASTE MATERIAL, AND DEBNIS INCLUDES TREES, STUPPS, 20.

OBTAIN AND PAY FOR ALL PERHITS, TESTS, INSPECTIONS, ETC. REQUIRED BY AGENCIES THAT HAVE JURISDICTION OVER
THE FROJECT. THE CONTRACTOR IS RESPONSIBLE FOR ALL BONDS, LETTERS OF CREDIT, OR CASH SURFERS RELATED

OBTAIN THE RIGHTS TO ANY WASTE AREA FOR DISPOSAL OF LINGUITABLE OR SUPPLIES MATERIAL BITHER SHOWN OR NOT

TO THE WORK. EXECUTE AND INSPECT WORK IN ACCORDANCE WITH ALL LOCAL AND STATE CODES, RULES, ORDNANCES,
SANITARY SEWER MAINTENANCE HOLES. COVERS SHALL BEAR I

"SANITARY SEWER" LABEL." DEBNIS, AND ALL THIRTHALS NOT DESIGNATE OF SALVAGE. THAS IT THAS TO THE CONSTRUCTION DEBNIS MICLOSES TREES, STRICT, PIPE, CONCRETE, ASPHALTIC CONCRETE, CANS, OR OTHER WASTE MATERIAL, FROM THE CONSTRUCTION DEPARTMENT.

OBTAIN THE RIGHTS TO ANY WASTE AREA FOR DISPOSAL OF UNSUITABLE OR SURFLUS MATERIAL EITHER SHOWN OR NOT SHOWN ON THE PLANS. ALL WORK IN DISPOSING OF SUCH MATERIAL SHALL BE CONSIDERED INCIDENTAL TO THE WORK.

ALL DISPOSAL MUST CONFORM TO APPLICABLE SOLID WASTE DISPOSAL PERMIT REGULATIONS. OBTAIN ALL NECESSARY 21.

PERMITS AT NO COST TO THE OWNER.

> 13. STRAIGHT LINE SAW-CUT EXISTING BITUMINOUS OR CONCRETE SURFACING AT THE FERMETER OF PAVEMENT REMOVAL AREAS. USE SAWS THAT PROVIDE WATER TO THE BLADE. TACK, AND MATCH ALL CONNECTIONS TO EXISTING BITUMINOUS PAVEMENT.

15. ALL MATERIALS REQUIRED FOR THIS WORK SHALL BE NEW MATERIAL CONFORMING TO THE REQUIREMENTS FOR CLASS. IND. GRADE, SIZE, QUALITY, AND OTHER DETAILS SPECIFIED HEREIN OR AS SHOWN ON THE PLANS. DO NOT USE

RECYCLED OR SALVAGED AGGREGATE, ASPHALTIC PAVEMENT, CRUSHED CONCRETE, OR SCRAP SHINGLES. UNLESS OTHERWISE INDICATED, THE CONTRACTOR SHALL FURNISH ALL REQUIRED MATERIALS.

RESTORE THE PUBLIC RIGHT-OF-WAY. REPLACE ANY CONCRETE CURB AND GUTTER, BITUMINOUS PAVEMENT, SIDEWALK, OR VEGETATIVE COVER DAMAGED BY THE CONSTRUCTION ACTIVITY. RESTORE DAMAGED TURF WITH SOD WITHIN THE PUBLIC RIGHT-OF-WAY. THE WORK AREA SHOWN IS GENERAL AND MAY NEED TO BE ADJUSTED IN THE FIELD.

When saying or drilling concrete or masonry, use saws that frovide water to the blade. Do not allow the slurry produced by this process to be tracked outside of the in-mediate work area or discharged into

18. ADJUST ALL CURB STOPS, VALVE BOXES, MAINTENANCE HOLE CASTINGS, CATCHBASIN CASTINGS, CLEANOUT COVERS,

INSTALL ALL PIPE WITH THE ASTM IDENTIFICATION NUMBERS ON THE TOP FOR INSPECTION. COMMENCE PIPE LAYING AT THE LOWEST POINT IN THE FROPOSED SEWER LINE. LAY THE PIPE WITH THE BELL BIO OR RECEIVING GROOVE BIO OF THE FIPE POINTING UPGRADE. WHEN CONNECTING TO AN EXISTING PIPE, UNCOVER THE EXISTING PIPE IN GROER TO ALLOW ANY ADJUSTMENTS IN THE PROPOSED LINE AND GRADE BEFORE LAYING ANY PIPE.

OR REGULATIONS PERTAINING TO THE PARTICULAR TYPE OF WORK INVOLVED.

ORTAIN PERMITS FROM THE CITY FOR WORK IN THE PUBLIC RIGHT-OF-WAY.

22. CONSTRUCT SANITARY SEWER, WATERMAIN, AND STORM SEWER UTILITIES IN ACCORDANCE WITH THE STANDARD SPECIFICATIONS FOR SEWER AND WATER CONSTRUCTION IN WISCONSIN, SIXTH EDITION, OR THE LATEST REVISED

23. TRACER WIRE: Locating requirements - a means to locate buried underground exterior non metallic sewers/mains must be provided with tracer wire or other methods in order to be located in accord with THE PROVISIONS OF THESE CODE SECTIONS AS PER 182.0715(2R) OF THE STATUTES

24. INSTALL ALL PIPE WITH THE ASTM IDENTIFICATION NUMBERS ON THE TOP FOR INSPECTION. COMMENCE PIPE LAYING AT THE LOWEST POINT IN THE PROPOSED SEWER LINE. LAY THE PIPE WITH THE BELL BIO OR RECEIVING GROOVE BIO OF THE PIPE POINTING UPGRADE. WHEN CONNECTING TO AN EXISTING PIPE, UNCOVER THE EXISTING PIPE IN ORDER TO ALLOW ANY ADJUSTMENTS IN THE PROPOSED LINE AND GRADE BEFORE LAYING ANY PIPE. DO NOT LAY PIPES IN WATER OR WHEN THE TRENCH CONDITIONS ARE UNSUITABLE FOR SUCH WORK.

SOLVENT-VELOED PLASTIC OR ON SCREWED-JOINT STEEL PIPE BECAUSE OF THE DANGER OF FIRE OR EXPLOSION FROM THE REACTION OF THE JOINT COMPOUNDS WITH THE CALCIUM HYPOTHLORITE. RETAIN THE TREATED WATER IN THE PIPELINE FOR AT LEAST ZA HOURS. MEASURE THE CHORINE RESIDUAL AT THE END OF THE 24 HOUR PERIOD. THE FREE CHLORINE RESIDUAL MUST BE AT LEAST 10 Mg/L MEASURED AT ANY POINT IN THE LINE. MEASUREMENT OF THE CHLORINE CONCENTRATION AT REGULAR INTERVALS SHALL BE IN ACCORDANCE WITH STANDARD METHODS, AWWA M-12, OR

SUPERVISION OF THE CITY PUBLIC WORKS DEPARTMENT. NOTIFY THE CITY AT LEAST 24 WORKING HOURS PRIOR TO ANY TESTING. PRESSURIZE THE WATERLINE TO 1034-KPA (150-PSI) GAUGE PRESSURE (MEASURED AT THE POINT OF LOWEST ELEVATION) BY MEANS OF A PUMP CONNECTED THE PIPE IN A SATISFACTORY MANNER. MAINTAIN THE TEST PRESSURE FOR A MINIMUM OF 2 HOURS

D2564. LAY ALL PVC PIPE ON A CONTINUOUS GRANULAR BED. INSTALLATION MUST COMPLY

 CLEANOUTS: INSTALL CLEANOUTS ON ALL SANITARY SEWER SERVICES. THE DISTANCE BETWEEN
CLEANOUTS IN HORIZONTAL, PIPING SHALL NOT EXCEED 100 FEET FOR PIPES 4-RICH AND OVER IN
SIZE. CLEANOUTS SHALL BE OF THE SAME NOMINAL SIZE AS THE PIPES THEY SERVE OR 6-RICH
DIAMETER MINIMUM FOR PIPES 6 INCHES IN DIAMETER OR GREATER. INCLIDE FROST SLEEVES AND CONCRETE FRAME AND PIPE SUPPORT. INSTALL A METER BOX FRAME AND SOLID LID (NEENAH R-1914-A, OR APPROVED EQUAL) OVER ALL CLEANOUTS.

5. TESTING: PRESSURE TEST ALL SANITARY SEWER LINES. TEST ALL FLEXIBLE SANITARY SEWER INES FOR DEFLECTION AFTER THE SEWER LINE HAS BEEN INSTALLED AND BACKFILL HAS BEEN IN PLACE FOR AT LEAST 30 DAYS. NO PIPE SHALL EXCEED A DEFLECTION OF 5%. IF THE TEST FAILS, MAKE NECESSARY REPAIRS AND RETEST.

UNLESS OTHERWISE INDICATED, USE REINFORCED, PRECAST, CONCRETE MAINTENANCE HOLES CONFORMING TO ASTIT CA78, FURNISHED WITH FRECAST BASES. SANITARY SEVER HAINTENANCE HOLES SHALL BE SUPPLIED WITH FRE-FORMICD INVERTS AND FLEMBLE REOFRENE SLEEVE CONNECTIONS FOR ALL LATERAL LINES 375 MM (IS INCHES) IN DIAMETER OR LESS, UNLESS OTHERWISE INDICATED. JOINTS FOR ALL PRECAST MAINTENANCE HOLE SECTIONS SHALL HAVE CONFINED, RUBBER "O"-RING GASKETS IN ACCORDANCE WITH ASTM C923. THE INSIDE BARREL DIAMETER SHALL NOT BE LESS THAN 48 INCHES.

INSTALL FLEXIBLE WATERTIGHT FRAME/CHIMNEY SEALS ON ALL SANITARY SEVER MAINTENANCE HOLES. USE EITHER MANUFACTURED MAINTENANCE HOLE FRAME/CHIMNEY SEALS OR ELASTOMERIC WATERPROOFING FRAME/CHIMNEY SEALS.

APPROVED EQUAL, ON ALL SANITARY SEWER MAINTENANCE HOLES. COVERS SHALL BEAR THE

THE MINIMUM DEPTH OF COVER FOR SANITARY SEWER WITHOUT INSULATION IS 5 FEET. INSULATE SANITARY SEWER SERVICES AT LOCATIONS WHERE THE DEPTH OF COVER IS LESS THAN 5 FEET. PROVIDE A MINIMUM INSULATION THICKNESS OF 2 INCHES. THE INSULATION MUST BE AT LEAST (A FEET WIDE AND CENTERED ON THE PIPE. INSTALL THE INSULATION BOARDS 6 INCHES ABOVE TH TOTS OF THE FIFES ON MECHANICALLY COMPACTED AND LEVELED FIFE BEDDING MATERIAL. USE HIGH DENSITY, CLOSD CELL, RIGID BOARD MATERIAL EQUIVALENT TO DOW STYROFOAM HI-4.0 FLASTIC FOAM INSULATION.

TRACER WIRE: LOCATING REQUIREMENTS - A MEANS TO LOCATE BURIED UNDERGROUND EXTERIOR NON METALLIC SEWERS/MAINS MUST BE PROVIDED WITH TRACER WIRE OR OTHER METHODS IN ORDER TO BE LOCATED IN ACCORD WITH THE PROVISIONS OF THE WISCONSIN STATUTES 182.0175(2R) AND THE WISCONSIN DEPARTMENT OF SAFETY AND PROFESSIONAL SERVICES SPS 82.30(II)(H).



KWIK TRIP **STORES** 



STORES

KWIK TRIP, Inc. P.O. BOX 2107 1626 OAK STREET LA CROSSE, WI 54602-2107 PH (608) 781-8988 FAX (608) 781-8960





CIVIL & ENVIRONMENTAL ENGINEERING, SURVEYING REI Engineering, INC. 4080 N. 20TH AVENUE WAUSAU, WISCONSIN 54401 PHONE: 715.675.9784 FAX: 715.675.4060


EMAIL : MAIL €REIENGINEERING.COM


2 STO AN 귑 CONVENIENCE AVENUE UTILITY WEBSTER / ALLOUEZ, \


E	# DATE	DESCRIPTION
4	<u> </u>	
Ē		
1		
1	DRAWN BY	NAP
1	SCALE	GRAPHIC
1	PROJ. NO.	7076A
ı	DATE	10/14/15 - BID DOCS
	SHEET	SP4

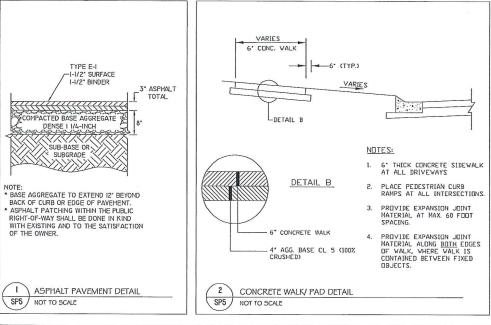

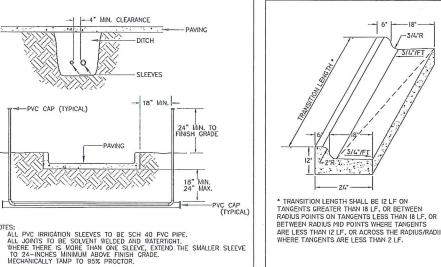

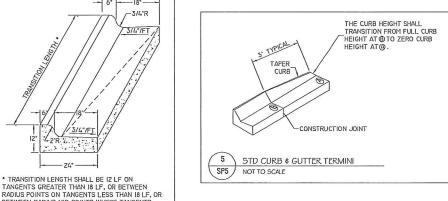


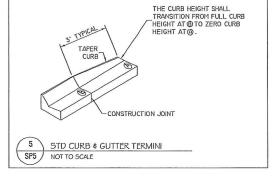

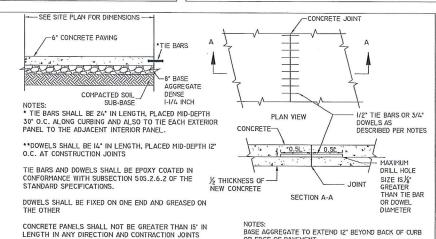


BASE AGGREGATE TO EXTEND IZ\* BEYOND BACK OF CURB

OR EDGE OF PAVEMENT

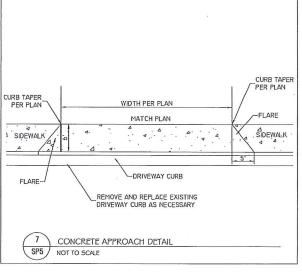


3 TYPICAL SLEEVING


SP5 NOT TO SCALE

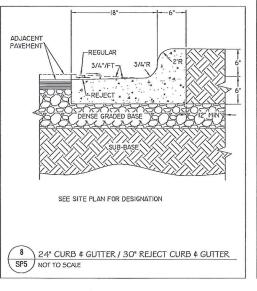


4 TRANSITION CURB \$ GUTTER

SP5 NOT TO SCALE

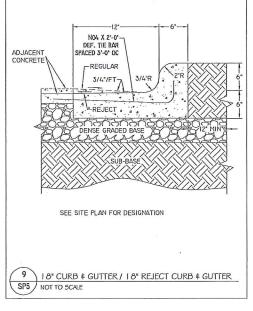

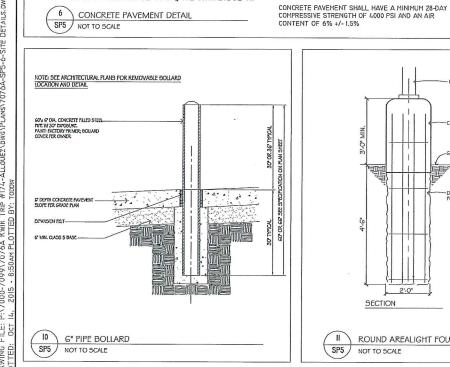

SHALL BE TO A MINIMUM DEPTH OF L THE CONCRETE DEPTH

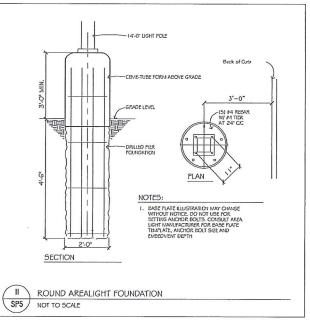

STORE **DETAILS** ONVENIENCE PLAN SITE

WEBSTER, ALLOUEZ, N Ö # DATE DESCRIPTION DRAWN BY NOT TO SCALE SCALE PROJ. NO. 7076A DATE 10/14/15 - BID DOCS SHEET SP5

AVENUE WI

KWIK

TRIP

**STORES** 

**STORES** 

KWIK TRIP, Inc.

1626 OAK STREET

PH. (608) 781-8988

FAX (608) 781-8960


LA CROSSE, WI 54602-2107


**CIVIL & ENVIRONMENTAL** 


ENGINEERING, SURVEYING


REI Engineering, INC. 4080 N. 20th AYENUE WAUSAU, WISCONSIN 54401 FHORE: 715.675.9784 FAX: 715.675.4060 EMAIL: MAIL@REIENGINEERING.COM


P.O. BOX 2107

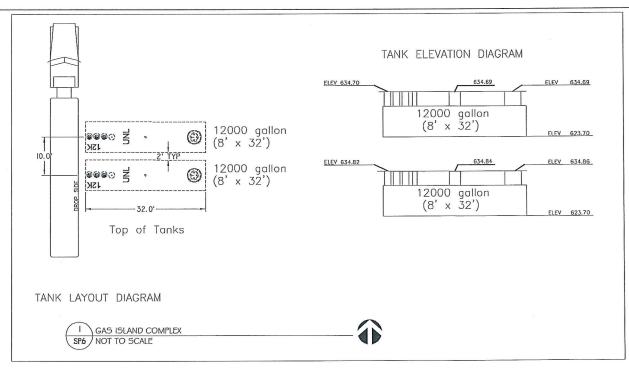


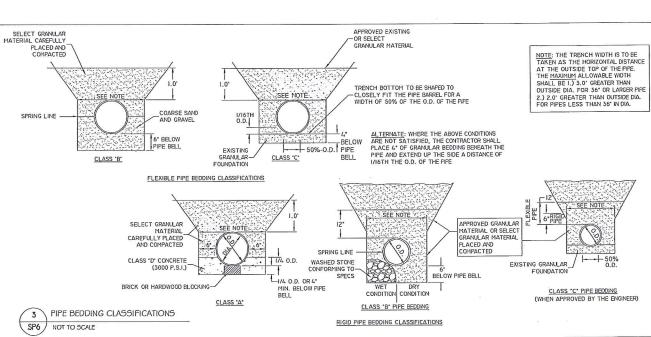


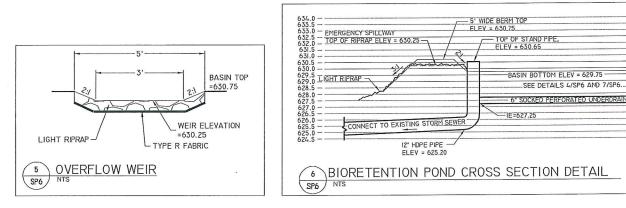

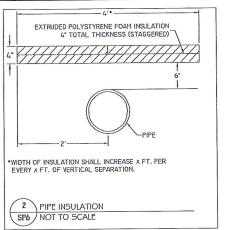

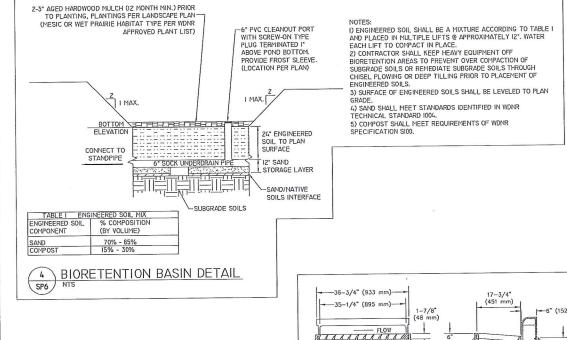

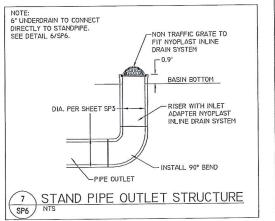

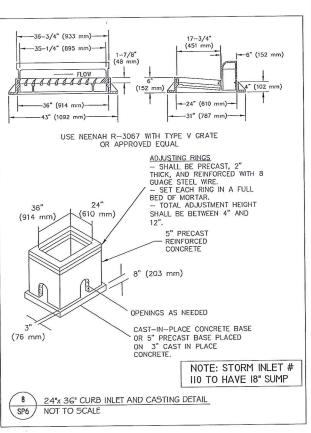





# **STORES**

KWIK TRIP, Inc. P.O. BOX 2107 1626 OAK STREET LA CROSSE, WI 54602-2107 PH. (608) 781-8988 FAX (608) 781-8960




CIVIL & ENVIRONMENTAL **ENGINEERING. SURVEYING** REI Engineering, INC. 4,080 N. 2014 AYENUE WAUSAU, WISCONSIN 54401 PHONE: 715,675,9784 FAX: 715,675,4060 EMAIL: MAIL@REIENGINEERING.COM

STOR **DETAILS** CONVENIENCE PLAN Ш SITI

AVENUE

WEBSTER, ALLOUEZ, \ # DATE DESCRIPTION <u> xx/xx/xx</u> DRAWN BY NAP NOT TO SCALE SCALE PROJ. NO. 7076A 10/14/15 - BID DOCS DATE SP6

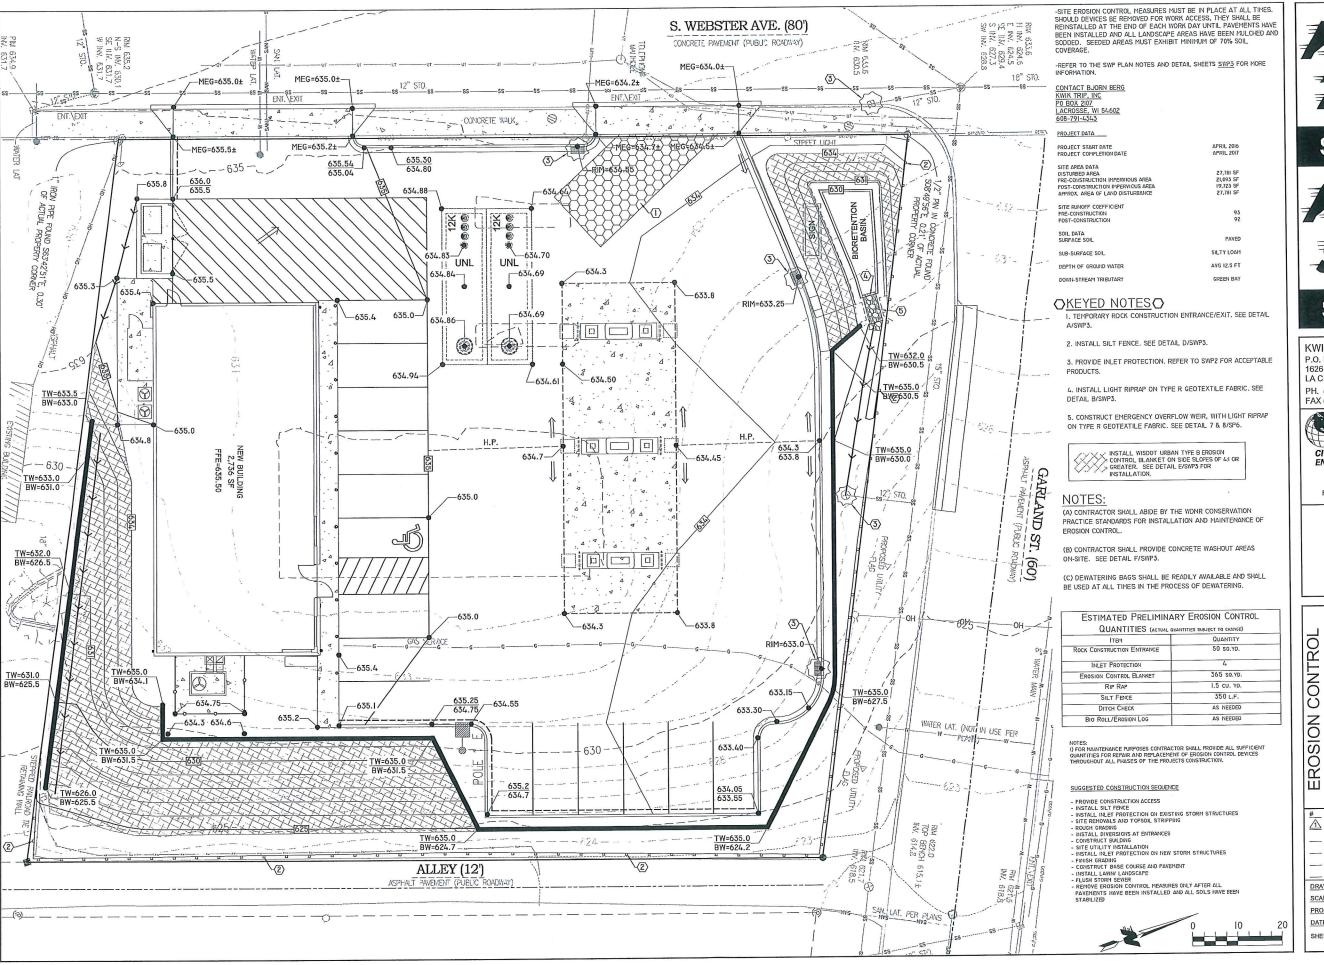

XWIX TRIP

STORES



**STORES** 

KWIK TRIP, Inc. P.O. BOX 2107 1626 OAK STREET LA CROSSE, WI 54602-2107

PH. (608) 781-8988 FAX (608) 781-8960



REI Engineering, INC. 4080 N. 20th AVENUE WAUSAU, WISCONSIN 54401 PHONE: 715.675.9784 FAX: 715.675.4060 EMAIL: MAIL@REIENGINEERING.COM

EROSION CONTROL PLAN CONVENIENCE STORE

AVENUE WI

EROSIC	CONVEN		WEBSTER A
# DAT	Έ	DESCRIPTION	ON
<u> </u>	XX/XX		
DRAWN BY		DI	DD
SCALE			
PROJ. NO.		7076	BA
DATE		10/14	/15 - BID DOCS
SHEET			SWP1

## APPLY FOR AND OBTAIN ALL NECESSARY PERMITS FOR CONSTRUCTION ACTIVITY.

STORHWATER POLLUTION PREVENTION PLAN (SWPPP): THE SWPPP CONSISTS OF THIS SUMMARY, PLAN SHEETS SWPI-4, AND THE STORHWATER MANAGEMENT PLAN. KEEP A COPY OF THE SWPPP, ALL CHANGES TO IT, AND INSPECTIONS AND MANTENANCE RECORDS AT THE SITE DURING THE CONSTRUCTION. DURING THE CONSTRUCTION FROCESS THE SWPPP WILL HAVE TO BE AMPIEDD FOR ALL CHANGES PEPFORMED BY THE CONTRACTOR. THE OWNER SHALL BE AWARE OF THE AMEMORENTS PRIOR TO CHANGES HADE TO THE SWPPP PLAN. ALL HOTES, PHOTOGRAPHS, RECORDED DATES, SKETCHES, REFERENCES, AND DIAGRAMS WILL HAVE TO BE RECORDED AND MADE AVAILABLE AS PART OF THE SWPPP PERMIT

INDIVIDUAL(s) PREPARING THE SWPPP FOR THE PROJECT, OVERSEEING INFLEMENTATION OF THE SWPPP, REVISING AND AMENDING THE SWPPP, AND AT LEAST ONE INDIVIDUAL ON THE PROJECT PERFORMING INSTALLATION, INSPECTION, MAINTENANCE, AND REPAIRS OF EMP'S MUST BE TRAINED. THE TRAINING MUST BE DONE BY A LOCAL, STATE, FEDERAL AGENCIES; PROFESSIONAL ORGANIZATION; OR OTHER ENTITITES WITH EXPERTISE IN EROSION PREVENTION, SEDIMENT CONTROL, OR PERMANENT STORMWATER MANAGEMENT.

RESPONSIBLE PARTIES: THE CONTRACTOR MUST DESIGNATE A PERSON KNOWLEDGEABLE AND EXPERIENCED IN THE AFFLICATION OF EROSION PREVENTION AND SEDIMENT CONTROL BMPS WHO WILL OVERSEE THE IMPLEMENTATION OF THE SWPPP, AND THE INSTALLATION, INSPECTION, AND MAINTENANCE OF THE EROSION PREVENTION AND SEDIMENT CONTROL BMPS BEFORE AND DURING CONSTRUCTION.

THE OWNER IS RESPONSIBLE FOR IDENTIFYING WHO WILL HAVE RESPONSIBILITY FOR THE LONG TERM OPERATION AND MAINTENANCE OF THE PERMANENT STORMWATER MANAGEMENT SYSTEMS

# OWNER CONTACT:

NAME: BJORN BERG

COMPANY: KWIK TRIP INC. Annress:

KWIK TRIP, INC. - STORE ENGINEERING

1626 OAK STREET, P.O. Box 2107

LA CROSSE, WI 54601-2107

(608) 791-4343 TELEPHONE:

# SITE INVESTIGATION, INSTALLATION, IMPLEMENTATION:

- PRIOR TO ANY WORK, CONTRACTOR SHALL VISIT THE SITE, DOCUMENT EXISTING CONDITIONS AS NECESSARY(PHOTOS, NOTES, ETC) AND NOTE STING DRAINAGE PATTERNS ON AND OFF SITE THAT ARE RELATED TO THE FROJECT. THESE NOTES SHALL BE PART OF THE SWPPF
- 2. INSTALL ALL TEMPORARY EROSION AND SEDEMENT CONTROL MEASURES INCLUDING SILT FENCE, ROCK CONSTRUCTION ENTRANCE(S), EROSON CONTROL BERMS, ROCK FILTERS, INLET AND CULVERT PROTECTION, ROCK /EARTH BERMS, AND SEDMENTATION BASINS. PROTECT ALL RECEIVING WATERS, CATCH BASINS, DITCHES, INLETS ETC. IN AND AROUND THE SITE. ALL PROTECTIVE AND PREVENTATIVE MEASURES MUST BE IN FLACE AND INSPECTED FRIOR TO BEGINNING SITE CLEARING, GRADING, OR OTHER LAND-DISTURBING ACTIVITY.
- PRIOR TO BEGINNING SITE CLEARING AND GRADING, PROTECT ALL STORM SEWER INLETS THAT RECEIVE RUNOFF FROM DISTURBED AREAS. IN ORDER TO PREVENT SEDIMENT FROM LEAVING THE SITE AND ENTERING THE DOWNSTREAM STORM SEWER SYSTEM, SEAL ALL STORM SEWER INLETS THAT ARE NOT NEEDED FOR SITE DRAIMAGE DURING CONSTRUCTION. PROTECT ALL OTHER STORM SEWER INLETS BY INSTALLING SEDIMENT CONTROL DEVICES, SUCH AS SILT SACKS, OR SIMILAR PRODUCT. STRAW BALES OR FABRIC UNDER THE GRATES ARE NOT ACCEPTABLE FORMS OF INLET PROTECTION. PROTECT NEW STORM SEWER INLETS AS THEY ARE COMPLETED. MAINTAIN STORM SEWER INLET PROTECTION IN PLACE UNTIL ALL SOURCES WITH TIAL FOR DISCHARGING TO THE INLETS ARE STABILIZED
- 4. BEFORE BEGINNING CONSTRUCTION, INSTALL A TEMPORARY ROCK CONSTRUCTION ENTRANCE AT EACH POINT WHERE VEHICLES EXIT THE CONSTRUCTION SITE WHEN AT ALL POSSIBLE CONTRACTOR SHALL DESIGNATE ONLY ONE ACCESS POINT FOR VEHICLES ENTERING AND EXITING THE SITE. THE ROCK ON THE ENTRACE WILL HAVE TO BE INSPECTED DAILY AND REPLACED OR ROCK SUPPLEMENTED BY THE CONTRACTOR WHEN OVER 50% OF THE VOIDS IN THE ROCK ARE FILLED. A CLEANING STATION SHOULD BE MADE AVAILABLE TO DRIVERS AND VISABLY SIGNED AS SUCH. PROVIDE SHOVELS, MS AND/OR HOSE WITH A WASH OUT AREA SO SOILS CAN BE REMOVED FROM VEHICLES ON SITE.
- 5. AVOID ENTIRE REMOVAL OF TREES AND SURFACE VEGETATION ALL AT ONCE WHENEVER FOSSIBLE AS THIS LIMITS THE AMOUNT OF SITE SUBSCEPTABLE TO EROSION. SCHEDULE CONSTRUCTION ZONES AND NOTE THIS ON THE SWPP PLAN IN ORDER TO EXPOSE THE SMALLEST PRACTICAL AREA OF SOIL AT ANY GIVEN TIME. UTILIZE VEGETATION REMOVED BY ON SITE GRINDING AND MULCHING AND USING THIS MATERIAL TO FROTECT
- 6. FOLLOWING INITIAL SOIL DISTURBANCE OR REDISTURBANCE, COMPLETE PERMANENT OR TEMPORARY STABILIZATION AGAINST EROSION DUE TO RAIN, WIND, AND RUNNING WATER WITHIN 7 CALENDAR DAYS ON ALL DISTURBED OR GRADED AREAS. THIS REQUIREMENT DOES NOT APPLY TO THOSE AREAS THAT ARE CURRENTLY BEING USED FOR MATERIAL STORAGE ON A DAILY BASIS OR FOR THOSE AREAS ON WHICH GRADING, SITE BUILDING, OR OTHER CONSTRUCTION ACTIVITIES ARE ACTIVELY UNDERWAY. PROVIDE TEMPORARY COVER ON ALL STACKED TOPSOIL PILES, AND OTHER AREAS OF OTHER CONSTRUCTION ACTIVITIES ARE ACTIVED OURSELING. TWO REPORT SOIL EROSION AND RAPID BURDOFF DURING THE CONSTRUCTION PERIOD. STOCKPILES CAN BE MULCHED, COVERED WITH POLY OR FABRIC, AND OR SEEDED DURING PROLONGED EXPOSURE. PROLONGED FERIODS OF OPEN, BARE EARTH WITHOUT GRASS COVER WILL NOT BE PERMITTED. STABILIZE ALL DISTURBED GREENSPACE AREAS WITH A MINIMUM OF 4" TOFSOIL INMEDIATELY AFTER FINAL SUBGRADE COMPLETION. SEED AND MULCH, OR SOD AND PROTECT THESE AREAS WITHIN 48 HOURS AFTER COMPLETION OF FINAL GRADING WORK (WEATHER PERMITTING). STABILIZE ALL DISTURBED AREAS TO BE PAVED USING EARLY APPLICATION OF GRAVEL BASE. STABILIZE THE NORMAL WHET HER PERMITTER OF ANY TEMPORARY OR PERMANENT DRAINAGE DITCH THAT CONVEYS WATER ROW THE CONSTRUCTION SITE, OR DIVERTS WATER AROUND THE CONSTRUCTION SITE, WITHIN 200 LINEAL FEET FROM THE PROPERTY EDGE, OR WITHIN 200 FEET FROM THE PROPERTY EDGE, OR WITHIN 200 FEET FROM THE FORT OF DISCHARGE TO ANY SURFACE WATER. STABILIZE TEMPORARY OR PERMANENT DRAINAGE DITCHES WITHIN 26 HOURS OF CONNECTIVE TO A SURFACE WATER. PROTECT OUTFALLS MINUMUM OF 200FEET DOWN STREAM AND TO THE SIDE OF THE DISCHARGE FOINT. ADDITIONAL SETTLING "FOTS" ACHIEVED BY FILTER LOGS OR FILTERED STICK BALES STAKED IN THE CHANNEL WILL DISSAPATE THE WATER ENERGY. PROVIDE PIPE OUTLETS WITH TEMPORARY PERMANENT ENERGY DISSIPATION WITHIN 24 HOURS OF CONNECTION TO A SURFACE WATER.
- RECEVING WATERS IT IS THE CONTRACTORS RESPONSIBILITY TO INSPECT THE SITE DISCHARGE POINT AS WELL AS DOWNSTREAM TO THE RECIVING BODY OF WATER (FOND, LAKE, STREAM, ETC.) ON A REGULAR BASIS INCLUDING AFTER EACH STORM EVENT AND DOCUMENT IF ANY DIFFERENCES OR CHANGES IN NORMAL IN DISCHARGE AND IF MATERIAL IS LEAVING THE CONSTRUCTION SITE. IF SO IT SHALL BE DOCUMENTED AND REMOVED

NOTE: ALL EROSION AND SEDIMENT CONTROL DEVICES WILL BE CHECKED BY THE CONTRACTOR AFTER EACH STORM EVENT AND BE MAINTAINED, OR IMPROVED UPON AFTER EVERY STORM EVENT TO ENSURE ADEQUATE PERFORMANCE.

A. WHEN WASHOUTS OCCUR ON THE SITE, CONCRETE WASHOUT WATER MUST BE CONTAINED IN A LEAK-PROOF CONTAINEMENT FACILITY OR IMPERIMEABLE LINER. LIQUID AND SOLID WASTES MAY NOT TOUCH THE GROUND AND THERE MUST NOT BE RUNOFF FROM THE CONCRETE WASHOUT

B. ON SITES WHERE CONCRETE WASHOUT AREAS ARE NOT FEASIBLE AS SHOWN ON THE DETAIL SHEET, ABOVE GROUND METHODS AND/OR OFF-SITE METHODS CAN BE LITH IZED AS APPROVED BY OWNER

C. CONCRETE WASHOUT MAY BE PROVIDED OFF-SITE BY CONCRETE CONTRACTOR OR CONCRETE SUPPLIER. AT AN APPROVED WASHOUT DISPOSAL AREA CONCRETE SUPPLIER MAY PROVIDE CONCRETE WASHOUT AREAS ON-BOARD THEIR TRANSPORTS FOR DISPOSAL OFF-SITE. CONCRETE CONTRACTOR VERIFY WITH SUPPLIER IN REGARDS TO PROVIDED CONCRETE WASHOUT AREAS ON AND OFF-SITE, AS NECESSARY.

D. LIMIT EXTERNAL WASHING OF TRUCKS AND OTHER CONSTRUCTION VEHICLES TO A DEFINED AREA PREFERABLY BEFORE THE CONSTRUCTION ACCESS/EXIT POINT. WASH VEHICLES ONLY ON AN AREA STABILIZED WITH STONE THAT DRAINS INTO AN APPROVED SEDIMENT TRAFFING DEVICE. CONTAIN RUNOFF AND PROPERLY DISPOSE OF WASTE. ENGINE DEGREASING IS PROHIBITED.

- SOLID WASTE: PROPERLY DISPOSE OF COLLECTED SEDIMENT, ASPHALT AND CONCRETE MILLINGS, FLOATING DEBRIS, PAFER, PLASTIC, FABRIC, CONSTRUCTION AND DEMOLITION DEBRIS, AND OTHER WASTES IN COMPLIANCE WITH STATE REQUIREMENTS.
- CASOLINE, PAINT, WASTEWATER, TOXIC MATERIALS, AND HAZARDOUS MATERIALS, OF THE DISCHARGE OF THE CONTROL OF THE C STORAGE AREAS IN ORDER TO FREVENT VANDALISM. STORAGE AND DISPOSAL OF HAZARDOUS MATERIALS MUST BE IN COMPLIANCE WITH
- MACHINERY: AND MECHANICALIZED EQUIPMENT THAT LEAKS WASTE SHALL HAVE A PROTECTIVE BARRIER OR CONTAINMENT UNDER THE DEVICE ADEQUATE TO CONTAIN THE WASTE. PROPERLY DISPOSE OF THE WASTE.

EROSION CONTROL :

APPLY NECESSARY MOISTURE TO THE CONSTRUCTION AREA AND HAUL ROADS TO PREVENT THE SPREAD OF DUST

CONTRACTOR SHALL UTILIZE COARSELY GROUND WOOD AND TREE MULCHES TO COVER EXPOSED SOILS. MULCHES SHALL BE SPORED ON SITE TO SUPPLEMENT AND USE IN PROBLEM AREAS DURING ALL PHAZES OF THE CONSTRUCTION PROJECT

CONTRACTOR SHALL USE STAR TACK OR OTHER ORGANIC SUBSTANCES IN SITUATIONS TO FREVENT SOIL FROM ERODING AWAY BY WIND OR RAIN

WHENEVER POSSIBLE CONTRACTOR SHALL GRADE AREAS OF SOIL TO LIMIT POTENTIAL OF EROSION, TO INCLUDE TRACKING PERPEDICULAR TO FALL LINE OF GRADES AS WELL AS DIVERTING WATER FLOWS FROM PROBLEMATIC AREAS ON THE SITE

FIBER BLANKETS, POLY/TARPS OR COVER MULCHES, DISKED MULCHES AND COMPOST CAN BE USED TO COVER TEMPORARILY EXPOSED AREAS FROM WIND AND RAIN. OTHER METHODS BY THE CONTRACTOR SHALL BE DOCUMENTED IN THE SWPPP.

## SEDIMENT CONTROL:

- A. ROAD DRAIN TOP SLAB MODEL RD 23 (FITS ROUGH OPENING FOR 2'X3' INLET), ROAD DRAIN TOP SLAB MODEL RD 27 (FITS ROUGH OPENING FOR 27" INJET), OR ROAD DRAIN TOP SLAB MODEL CG 3067 (FITS NEENAH CASTING WITH 35-1/4"x17-3/4" DIPENSIONS) MANUFACTURED BY WIMCO, 799 THEIS DRIVE, SHAKOPEE, MN, 55379, PHONE (952) 233-3055. OR AFFROVED EQUAL
- B. SILT SACK MANUFACTURED BY ACF ENVIRONMENTAL, 2831 CARDWELL ROAD, RICHMOND, VA. 23234, PHONE (800) 448-3636, OR
- C. INFRASAFE SEDIMENT CONTROL BARRIER. INSTALL GEOTEXTILE SOCK ON THE OUTSIDE OF THE BARRIER IN ORDER TO TRAP ADDITIONAL STANDARD FRAMES ARE AVAILABLE TO FIT 24" TO 30" DIAMETER AND 2"X3" OPENINGS. DISTRIBUTED BY ROYAL ENTERPRISES AMERICA, 30622 FOREST BOULEVARD, STACY, MN, 55079, PHONE (65I) 462-2130, OR APPROVED EQUAL
- D. RIDGE BAG ROCK LOG. USE ROCK LOGS ONLY FOR CURB INLETS AFTER PAVEMENT IS IN PLACE. MANUFACTURED BY RED BARN RIDGE, 3155 COUNTY ROAD 136, SAINT CLOUD, MN, 35301, PHONE (320) 253-3744. OR AFFROVED EQUAL
- E. INFLATABLE DRAIN PLUGS BY INTERSTATE PRODUCTS WWW.INTERSTATEPRODUCTS.COM OR APPROVED FOUAL

<u>RIPRAP:</u>
PLACE A 450 MM (18 INCH) THICK LAYER OF RIPRAP ONTO A 225 MM (9 INCH) THICK LAYER OF GRANULAR FILTER MATERIAL AT LOCATIONS INDICATED ON THE FLAN IN ACCORDANCE WITH WISDOT SPECIFICATION 606. INSTALL TWO LAYERS OF MEDIUM DUTY GEOTEXTILE FABRIC (WIDDOT THE SECTION 645.5.7) BENEATH THE GRANULAR FILTER MATERIAL. AT PIPE OUTFALLS CONFIGURE THE INSTALLATION AS SHOWN ON DETAIL SHEET FOR THE SIZE OF PIPE INDICATED AND EXTEND THE GEOTEXTILE FABRIC UNDER THE CULVERT AFRON A MINIMUM OF 3 FEET. FOR PIPE SIZES SMALLER THAN 300 MM (12 INCH) DIAMETER, THE MINIMUM QUANTITY OF RIFRAP AND FILTER BLAIMET SHALL BE NO LESS THAN THAT REQUIRED FOR 300 MM. (12 INCH) DIAMETER PIPES.

SILT FENCE: INSTALL AND MAINTAIN FER WIDNR CONSERVATION PRACTICE STANDARD 1056.

INSTALL SILT FENCE ALONG THE CONTOLIR (ON A LEVEL HORIZONTAL PLANE) WITH THE ENDS TURNED UP (J-HOOKS) IN ORDER TO HELP POND WATER BEHIND THE FENCE. INSTALL THE SILT FENCE ON THE UPHILL SIDE OF THE SUPPORT POSTS. PROVIDE A POST SPACING OF 1.2 M (4 FEET) OR LESS.

DRIVE POSTS AT LEAST 0.6 M (2 FEET) INTO THE GROUND. ANCHOR THE SILT FENCE FASRIC IN A TRENCH AT LEAST 152 NM (6 INCHES) DEEP AND 152 MM (6 INCHES) WIDE DUG ON THE UPSLOPE SIDE OF THE SUPPORT POSTS. LAY THE FABRIC IN THE TRENCH AND THEN BACKFILL AND COMPACT WITH A VIBRATORY PLATE COMPACTOR. MAKE ANY SPLICES IN THE FABRIC AT A FENCE POST. AT SPLICES, OVERLAP THE FABRIC AT LEAST 152 MM (6 INCHES), FOLD IT OVER, AND SECURELY FASTEN IT TO THE FENCE POST. SILT FENCE SUPPORTING FOSTS SHALL BE 51 MM (2 INCH) SQUARE OR LARGER HARDWOOD, PINE, OR STANDARD T- OR U-SECTION STEEL POSTS. T- OR U-SECTION STEEL POSTS SHALL WEIGH NOT LESS THAN 1.8602 KG PER METER (1.25 LB FER LINEAL FOOT). POSTS SHALL HAVE A MINIMUM LENGTH OF 1524 MM (5 FEET). POSTS SHALL HAVE PROJECTIONS TO FACILITATE FASTENING THE FABRIC AND PREVENT SLIPPAGE. GEOTEXTILE FABRIC SHALL MEET THE REQUIREMENTS OF WIDOT STANDARD PACIFICATION 628 FOR PREASSEMBLED SILT FENCE, FURNISHED IN A CONTINUOUS ROLL IN GODER TO AVIOD SPLICES. GEOTEXTILE FARRIC SHALL BE UNIFORM IN TEXTURE AND APPEARANCE AND HAVE NO DEFECTS, FLAWS, OR TEARS. THE FABRIC SHALL CONTAIN SUFFICIENT ULTRAVIOLET (UV) RAY INHIBITOR AND STABILIZERS TO PROVIDE A MINIMUM TWO-YEAR SERVICE LIFE OUTDOORS. FABRIC COLOR SHALL BE INTERNATIONAL ORANGE. IN HIGH TRAFFIC AREAS CONTRACTOR SHALL REINFORCE SILT FENCE WITH WIRE FENCING AND METAL POSTS. EXTREME CIRCUMSTANCES WILL REQUIRE TEMPORARY CONCRETE MEDIAN SECTIONS TO SUPPORT MATERIAL BACKING OF STOCK FILED SOIL OR FILLED EARTH.

INSTALL SILTFERCE, OR OTHER EFFECTIVE SEDIMENT CONTROLS, AROUND ALL TEMPORARY SOIL STOCKPILES. LOCATE SOIL OR DIRT STOCKFILES
CONTAINING MORE THAN IO CUBIC YARDS OF MATERIAL SUCH THAT THE DOWNSLOPE DRAINAGE LENGTH IS NO LESS THAN 8 M (25 FEET) FROM THE
TOE OF THE PILE TO A ROADWAY OR DRAINAGE CHAINNEL. IF REMAINING FOR MORE THAN SEVEN DAYS, STABLIZE THE STOCKFILES BY MULCHING,
VEGETATIVE COVER, TARPS, OR OTHER MEANS. CONTROL EROSION FROM ALL STOCKPILES BY FLACKING SILT FERCE BARRIERS AROUND THE PILES. DURING STREET REPAIR, COVER CONSTRUCTION SOIL OR DIRT STOCKPILES LOCATED CLOSER THAN 8 M (25 FEET) TO A ROADWAY OR DRAINAGE CHANNEL WITH TARPS, AND PROTECT STORM SEWER INLETS WITH SILT SACKS OR STAKED SILTFERCE. DO NOT STOCK PILE SOIL OR MATERIAL NEAR CATCH BASINS OR DRAINAGE WAYS.

STONE TRACKING PAD (TEMPORARY ROCK CONSTRUCTION ENTRANCE:
INSTALL AND MAINTAIN FER WIDNR CONSERVATION PRACTICE STANDARD 1057. USE SINCH TO 6" DIAMETER ROCK. PLACE THE AGGREGATE IN A
LAYER AT LEAST 300 MM (12 INCHES) THICK ACROSS THE ENTIRE WIDTH OF THE ENTRANCE. EXTEND THE ROCK STATEMENT AT LEAST AGGREGATE IN OPER TO FFFT) INTO THE CONSTRUCTION ZONE. USE A WIDOT TYPE R PERMEABLE GEOTEXTILE FABRIC MATERIAL BENEATH THE AGGREGATE IN ORDER TO PREVENT MIGRATION OF SOIL INTO THE ROCK FROM BELOW. MAINTAIN THE ENTRANCE IN A CONDITION THAT WILL PREVENT TRACKING OR FLOWING OF SEDIMENT ONTO PAYED ROADWAYS. PROVIDE PERIODIC TOP DRESSING WITH ADDITIONAL STONE AS REQUIRED. CLOSE ENTRANCES NOT FROTECTED BY TEMPORARY ROCK CONSTRUCTION ENTRANCES TO ALL CONSTRUCTION TRAFFIC.

FE CONSTRUCTION PROCESS OR IF NOTED ON THE PLAN THE CONTRACTOR SHALL CONSTRUCT TEMPORARY SEDIMENT BASIN(S). AS FER GENERAL IN THE CONSTRUCTION PROCESS OR IT ROTED OF THE PLANT HE PLANT HE CONTRACTOR STALL CONSTRUCT THE PROPERTY BASINS THE PLANT HE PLAN

# DEWATERING:

IF DEWATERING IS REQUIRED AND SUMP PUMPS ARE USED. ALL FUMPED WATER MUST BE DISCHARGED THROUGH AN EROSION CONTROL FACILITY CEMPORARY SEDIMENTATION BASIN, ORIT CHAMBER, SAND FILTER, UPFLOW CHAMBER, HYDRO-CYCLONE, SWIRL CONCENTRATOR, DEWATERING BAG OR
OTHER APPROPRIATE FACILITY) PRIOR TO LEAVING THE CONSTRUCTION SITE. PROPER ENERGY DISSIPATION MUST BE FROWDED AT THE OUTLET OF THE FUMP SYSTEM. DISCHARGE CLEAR WATER ONLY. TO ACHIEVE BETTER SEPARTION OF THE MATERIAL SUSPENDED IN THE WATER A BIODEGRADABLE NON TOXIC FLOCCULANT AGENT MAY BE REQUIRED.

FOR MORE INFORMATION AND MATERIALS GO TO BY INTERSTATE PRODUCTS WWW.INTERSTATEFRODUCTS.COM

## INSPECTIONS-MAINTENANCE-DAILY RECORD-AMEND THE SWPP PLAN

- CONTRACTOR SHALL INSPECT ALL EROSION AND SEDIMENT CONTROL DEVICES, STABILIZED AREAS, AND INFILTRATION AREAS ON A <u>DAILY BASIS</u> UNTIL LAINO-DISTURBING ACTIVITY HAS CEASED. THEREAFTER, INSPECT AT LEAST ON A <u>WEEKLY BASIS</u> UNTIL VEGETATIVE CORE SESTABLISHED. INSPECT ALL EROSION AND SEDIMENT CONTROL DEVICES, STABILIZED AREAS, AND INFILTRATION AREAS WITHIN 24 HOURS AFTER A RAINFALL EVENT GREATER THAN 0.5 INCHES IN 24 HOURS. REMOVE ACCUMULATED SEDIMENT DEPOSITS FROM EBHIND EROSION AND SEDIMENT CONTROL DEVICES AS NEEDED. DO NOT ALLOW SEDIMENT TO ACCUMULATE TO A DEPTH OF MORE THAN ONE-THIRD OF THE HEIGHT OF THE EGNISHON AND SEDIMENT CONTROL DEVICES. IMMEDIATELY REPLACE DETERIORATED, DAHAGED, ROTTED, OR MISSING EROSION CONTROL DEVICES.
  DOCUMENT INSPECTIONS AND DATES OF RAINFALL EVENTS. MAINTAIN A WRITTEN LOG OF ALL REFECTION, MAINTBIANCE, AND REPAIR
  ACTIVITIES RELATED TO EROSION AND SEDIMENT CONTROL FACILITIES. ALL NOFUNCTIONAL BIPPS WITH EXPAIRED, REPLACED, OR
  SUPPLEMENTED WITH FUNCTIONAL BIPPS WITHIN 24 HOURS AFTER DISCOVERY, OR AS SOON AS FIELD CONDITIONS ALLOW ACCESS.
- 2. ALL INSPECTIONS AND MAINTENANCE ACTIVITIES MUST BE RECORDED IN WRITING DAILY IN A DETAILED RECORD(NOTES, PHOTOGRAPHS, SKETCHES, ETC, AND KEPT WITH THE SWPPP BY THE CONTRACTOR.
- 3. CONTRACTOR SHALL REMOVE ALL SOILS AND SEDIMENTS TRACKED OR OTHERWISE DEFOSITED ONTO ADJACENT FROFERTY, PAVEMENT AREAS, SIDEWALKS, STREETS, AND ALLEYS. REMOVAL SHALL BE ON A <u>DAILY BASIS</u> THROUGHOUT THE DURATION OF THE CONSTRUCTION AND/OR AS DIRECTED BY THE CITY. CLEAN PAVED ROADWAYS BY SHOVELING OR WET-SWEEPING. DO NOT DRY SWEEP. IF NECESSARY, SCRAFE PAVED SURFACES IN ROBER TO LOOSEN COMPACTED SEDIMENT MATERIAL FROM TO SWEEPING. HAUL SEDIMENT METRIAL TO A SUITABLE DISPOSAL AREA. STREET WASHING IS ALLOWED ONLY AFTER SEDIMENT HAS BEEN REMOVED BY SHOVELING OR SWEEPING.
- 4. ALL SOIL HAULED FROM THE SITE SHALL BE ACCOUNTED FOR AND DOCUMENTED IN THE SWPP BY THE CONTRACTOR. ITS FINAL DESTINATION AND HOW THE SOIL HAS BEEN STORED AND STABILIZED.
- 5. CONTRACTOR SHALL MAINTAIN ALL TEMPORARY EROSION AND SEDIMENT CONTROL DEVICES IN PLACE UNTIL THE CONTRIBUTING DRAINAGE AREA HAS BEEN STABILIZED (HARD-SURFACED AREAS PAVED AND VEGETATION ESTABLISHED IN GREENSPACE). REPAIR ANY RILLING, GULLY FORMATION, OR WASHOUTS. AFTER FINAL ESTABLISHMENT OF FERMANENT STABILIZATION, REMOVE ALL TEMPORARY SYNTHETIC, STRUCTURAL, AND IONBIODEGRADABLE EROSION AND SEDIMENT CONTROL DEVICES AND ANY ACCUMULATED SEDIMENTS. DISPOSE-OF OFF SITE. RESTORE FERMANENT SEDIMENTATION BASINS TO THEIR DESIGN CONDITION IMMEDIATELY FOLLOWING STABILIZATION OF THE SITE.
- CONTRACTOR SHALL CLEAN SEDIMENTATION RASINS, STORM SEWER CATCHBASINS, DITCHES, AND OTHER DRAINAGE FACILITIES AS REQUIRED IN ORDER TO MAINTAIN THEIR EFFECTIVENESS. TEMPORARY AND PERMANENT SEDIMENTATION BASINS MUST BE DRAINED AND THE SEDIMENT REMOVED WHEN THE DEPTH OF SEDIMENT COLLECTED IN THE BASIN REACHES 1/2 OF THE STORAGE VOLUME. DRAINAGE AND REMOVAL MUST BE COMPLETED WITHIN 72 HOURS, OR AS SOON AS FIELD CONDITIONS ALLOW ACCESS
- CONTRACTOR SHALL INSPECT INFILITRATION AREAS TO ENSURE THAT NO SEDIMENT FROM ONGOING CONSTRUCTION ACTIVITIES IS ACCUMULATING.
- 8. EVERY VEHICLE SHALL NOT TRACK MATERIAL OFF-SITE. CLEAN THE WHEELS OF CONSTRUCTION VEHICLES IN ORDER TO REMOVE SOLS BEFORE THE EHICLES LEAVE THE CONSTRUCTION SITE. WASH VEHICLES ONLY ON AN AREA STABILIZED WITH STONE THAT DRAINS INTO AN AFFROVED
- CONTRACTOR SHALL REINFORCE EROSION CONTROL FACILITIES IN AREAS WHERE CONCENTRATED FLOWS OCCUR (SUCH AS SWALES, DITCHES, AND AREAS IN FRONT OF CULVERTS AND CATCHASINS) BY BACKING THEN WITH ROCK BACS, SNOW FENCE, WHE MESH, OR STIFF PLASTIC MESH REINFORCEMENT UNITLE PAYING AND TURF ESTABLISHMENT OPERATIONS HAVE BEEN CONFIETED. POSTS FOR THE RESPORCING FENCE SHALL BE (A-INCH) DIAMETER WOOD POSTS, OR STANDARD STEEL FENCE POSTS WEIGHING NOT LESS THAN (I.3 LBS) FER LINEAL FOOT, WITH A MINIMUM LENGTH OF (30 INCHES) PLUS BURIAL DEPTH. SPACE POSTS FOR THE REINFORCING FENCE AT INTERVALS OF (I0 FEET) OR LESS. DRIVE POSTS FOR THE REINFORCING FENCE AT LEAST (2 FEET) INTO THE GROUND.

# GENERAL SOLL STABILIZATION:

ESTABLISHMENT OF LAWN, PRAIRIE/WILDFLOWER AND/OR PLANT BED AREAS WILL BE NOTED ON THE LANDSCAFE PLAN

TO FASURE STABILIZATION OF SOILS. RESTAKING OF SOD WHERE APPLICABLE, PROPER WATERING AND MULCH MAINTENANCE WILL BE REQUIRED. TO ENSURE STABILIZATION OF SOILS, RESTAINED OF SOU WHERE APPLICABLE, PROPER MATERIAIS AND POLCH PARKINGAINE HILL BE RECORDED.

INSPECT SEEDED OR SODDED AREAS ON A TIMELY DAY-TO-DAY BASIS. IN THE EVENT OF A SEEDING FALURE, RESEED AND REPULCH THE AREAS
WHERE THE ORIGINAL SEED HAS FAILED TO GROW AND PERFORM ADDITIONAL WATERING AS NECESSARY AT NO ADDITIONAL COST TO THE OWNER.

SPECIAL MAINTENANCE PROVISIONS FOR WILD AND PRAIRIE GRASS SEEDED AREAS AS NOTED IN THE LANDSCAPE FLAN. PROMPTLY REPLACE ALL SOD THAT DRIES OUT TO THE POINT WHERE IT IS PRESUMED DEAD AND ALL SOD THAT HAS BEEN DAMAGED, DISPLACED, WEAKENED, OR HEAVILY INFESTED WITH WEEDS AT NO ADDITIONAL COST TO THE OWNER. .

IN AREAS TO BE TEMPORARILY SEEDED, USE INTRODUCED SEED MIXTURE EQUIVALENT TO WISDOT #10 OR #20. APPLY SEED MIXTURE FER WISDOT 630.3,3,5. INCORPORATE A FERTILIZER (SLOW RELEASE TYPE WITH 10 WEEK RESIDUAL) CONSISTING OF 23-0-30 (%N-P-K) INTO THE SOIL AT AN APPLICATION RATE OF (200 LBS PER ACRE) BY DISKING FRIOR TO SEEDING. IN PROBLEMATIC AREAS IT MAY BE NECESSARY TO USE A LOW IS ORGANIC FERTILIZER IN CASES WHERE SEEDS MAY NOT GERMINATE. IF THIS IS THE CASE, SEED AND FERTILIZER SHALL BE DISKED INTO THE SURFACE AND MULCHED PROPERLY TO ENSURE GERMINATION AND UPTAKE OF THE PHOSPHORUS BY THE SEED

TO ENSURE ADEQUATE GERMINATION OF THE SEED THE WORK WILL BE PERFORMED AS FOLLOWS:

SPRING- FROM APRIL | THROUGH MAY 15.

FAIL- FROM APRIL | THROUGH MAY 15.

FAIL- FROM AUGUST 15 TO SEPTEMBER 20.

AFTER SEPTEMBER 20, WAIT UNTIL OCTOBER 30 TO PERFORM DORMANT SEEDING. DORMANT SEEDING WILL ONLY BE ALLOWED IF THE MAXIMUM SOIL. TEMPERATURE AT A DEPTH OF (I INCH) DOES NOT EXCEED (40 DEGREES F) IN ORDER TO PREVENT GERMINATIO

IN SEEDED AREAS WITH SLOPES STEEPER THAN 4:1 AND LENGTHS LESS THAN (50 FEET), INSTALL BIODEGRADABLE EROSION CONTROL BLAIMETS UNIFORMLY OVER THE SOIL SURFACE BY HAND WITHIN 24 HOURS AFTER SEEDING IN ACCORDANCE WITH MANUFACTURERS RECOMMEDIATIONS. US WISDOT URBAN TYPE B OR OWNER APPROVED EQUAL.

IN AREAS WHERE IRRIGATION IS TO BE INSTALLED, CONTRACTOR SHALL WORK IN ZONES TO FINISH GRADE AND INSTALL THE SYSTEM IN ZONES. IN AREAS WHERE INMINISTRATION TO BE INSTALLED, CONTINGLOW AS TABLE THOSE IN COLORS TO AN EXCENDING THE OWNER THE OWNER AND THE CHARLES THAT EXHIBIT MINIMUM OF 70% LAWIN VEGETATIVE COVERAGE. IF SILT FENCE HAS TO BE REMOVED TO INSTALL THE IRRIGATION SYSTEM, IT SHALL BE REINSTALLED AT THE END OF EACH WORK DAY OR USE BIO ROLLS TO PROVIDE PROTECTION DURING THE INSTALLATION PROCESS UNTIL LAWIN AREAS HAVE SOD AND/OR PLANT BEDS ARE MULCHED

IN AREAS TO BE SODDED, SILT FENCE CAN BE REMOVED SHORT TERM FOR WORKING, BUT EXPOSED SOIL AREAS SHALL BE SODDED OR EROSION

NOTE: THE PROJECT'S LANDSCAPE PLAN IS PART OF THE SWPP FOR SOIL STABILIZATION. REFERENCES SHALL BE MADE TO THE APPROVED LANDSCAPE PLAN. AMENDMENTS TO THE LANDSCAPE PLAN SHALL BE APPROVED BY THE OWENER AND DOCUMENTED AS PART OF THE SWPP



KWIK TRIP, Inc. P.O. BOX 2107 1626 OAK STREET LA CROSSE, WI 54602-2107 PH (608) 781-8988 FAX (608) 781-8960



ō O ONTR( ST ONVENIENCE CO SION Ш

	$\circ$	≥₹
# DATE	DESCRIP	TION
<u> </u>	/XX	
DRAWN BY		TAW
SCALE	NOT	TO SCALE
PROJ. NO.	70	076A
DATE	10/	14/15 - BID DOCS
SHEET		SWP2

AVENUE WI

EZ,

EBST


POLLUTION CONTROL:


I. DESIGNATE A CONCRETE WASH-OUT AND TRUCK WASH AREA:

MAKE IT VISIBLE IN THE FIELD TO VEHICLE OPERATORS AND NOTE THIS ON THE SWPP PLAN.

HAZARDOUS MATERIALS: PROPERLY DISPOSE OF ALL WASTE AND UNUSED BUILDING MATERIALS (INCLUDING GARZAGE DEBRIS, CLEANING WASTES, OIL.

EMERGENCY SPILL STATION: CONTRACTOR SHALL LOCATE AND SIGN AN EMERGENCY SPILL STATION THAT HAS NECESSARY CONTAINMENT OR CLEANUP DEVICES FOR ALL WORKERS TO ACCESS.

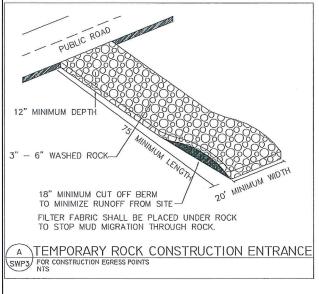


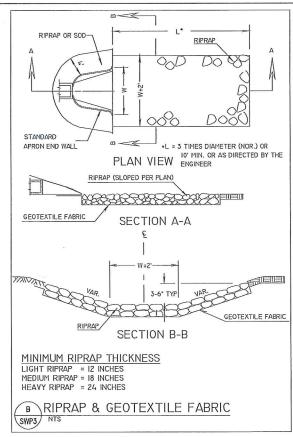


EROSION CONTROL BLANKET(SEEDED AREAS) ON SIDE 9LOPES OF 31 OR GREATER AND STORM WATER BASINS BIO-DEGRADABLE, DOUBLE NETTED, LIGHT DUTY (HEAVY DUTY IN DRANAGE SINALES) (WisDOT CLASS | TYPE B) ANCHOR TRENCH (SEE DETAIL AND NOTES BELOW) OVERLAP END JOINTS MINIMUM OF 6" AND STAPLE OVERLAP AT 1.5' INTERVALS. OVERI AP STAPLE DENSITY SHALL BE A LONGITUDINAL JOINTS MINIMUM OF 3 U-SHAPED 8", 11 GAUGE METAL STAPLES PER MINIMUM OF 6' SQUARE YARD (THIS MAY VARY AS DIRECTED BY GOVERNING AUTHORITY). ANCHOR TRENCH

1. DIG 6" X 6" TRENCH


2. LAY BLANKET IN TRENCH 1' TO 3' 3. STAPLE AT 1.5' INTERVALS 4. BACKFILL WITH NATURAL SOIL AND COMPACT 5. BLANKET LENGTH SHALL NOT EXCEED 100' WITHOUT AN ANCHOR TRENCH D EROSION CONTROL BLANKET INSTALLATION SWP3

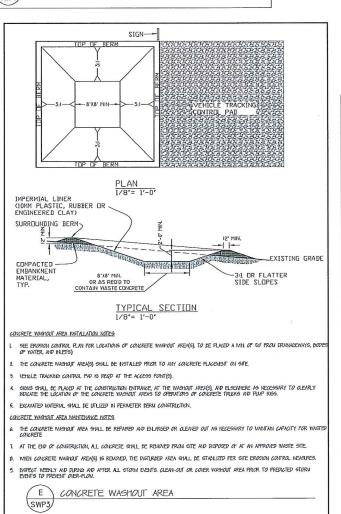

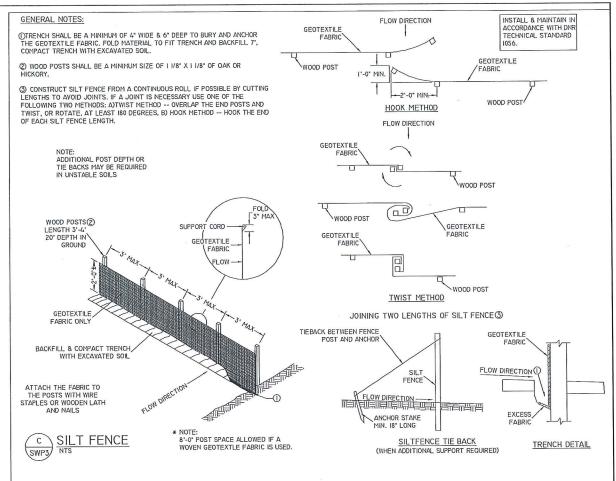

ALL EROSION CONTROL MEASURES TO BE INSTALLED

AND MAINTAINED PER WDNR STANDARDS http://dnr.wi.gov/org/water/wm/nps/stormwater/techstds.htm

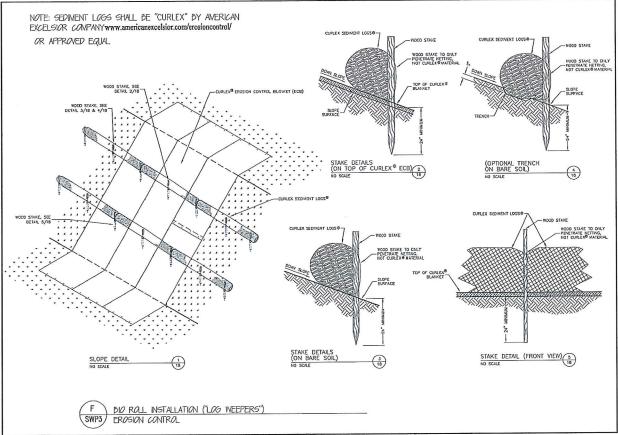



STORES



**STORES** 

KWIK TRIP, Inc. P.O. BOX 2107 1626 OAK STREET LA CROSSE, WI 54602-2107 PH. (608) 781-8988 FAX (608) 781-8960




EROSION CONTROL
DETAILS
CONVENIENCE STORE
WEBSTER AVENUE
ALLOUEZ, WI

# DATE DESCRIPTION

XXXXXXXX

DRAWN BY NAP
SCALE NOT TO SCALE
PROJ. NO. 7076A
DATE 10/14/15-BID DOCS
SHEET SWP3

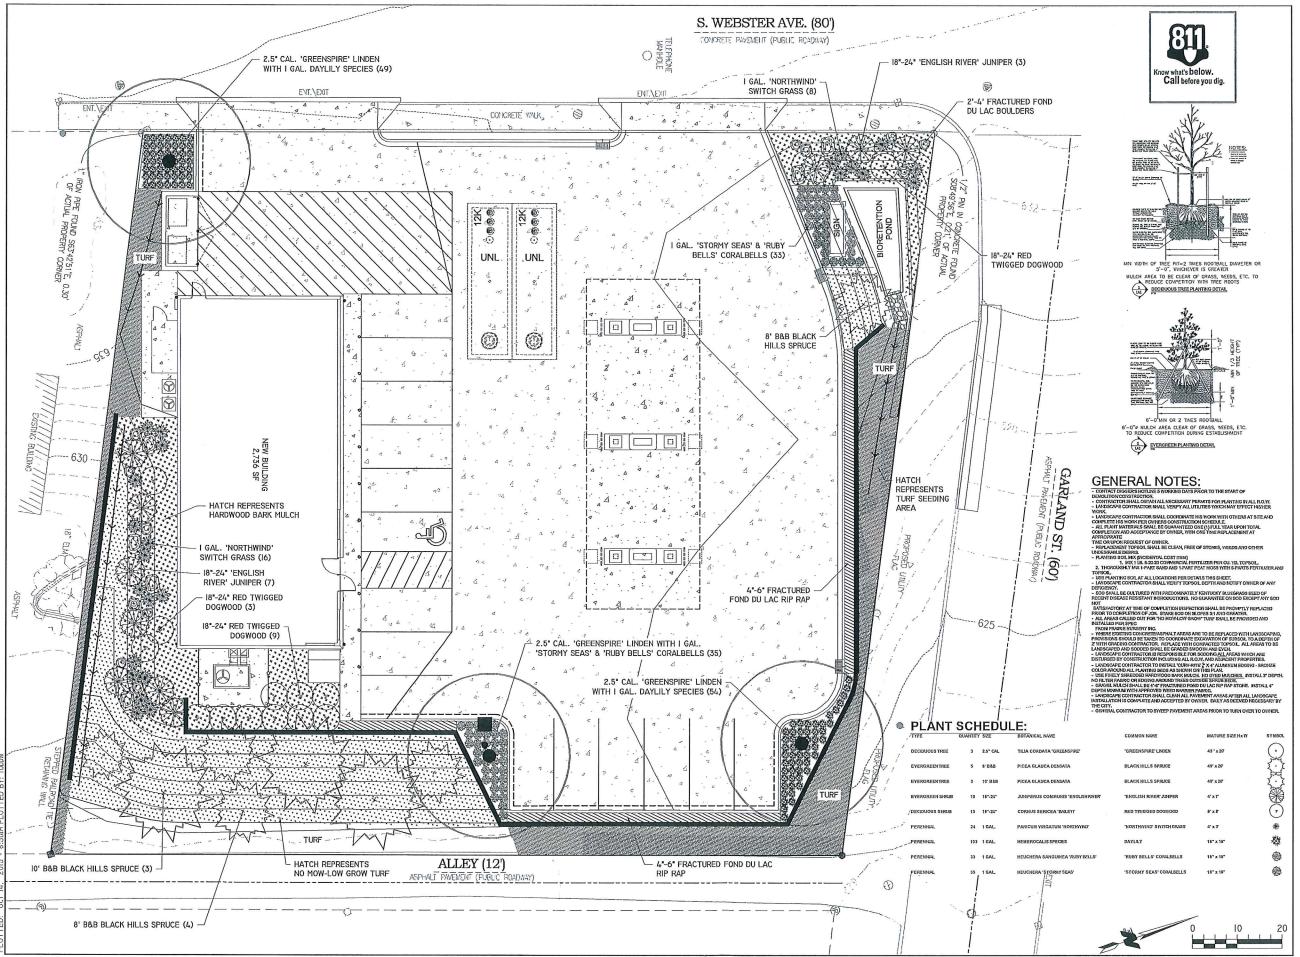







KWIK TRIP, Inc. P.O. BOX 2107 1626 OAK STREET LA CROSSE, WI 54602-2107 PH. (608) 781-8988 FAX (608) 781-8960



REI Engineering, INC. 4080 N. 20TH AVENUE WAUSAU, WISCONSIN 5440I FHOXE: 715.675.9784 FAX: 715.675.4060 EMAIL: MAIL@REIENGINEERING.COM



revi DESIGN, LLC. design | build | maintai 911 sixth street wausau| wi | 54403 715.355.REVI(7384) www.revi-design.com


> : AVENUE WI

LANDSCAPE PLAN
ONVENIENCE STORE

LAND	CONVEN	WEBSTER, ALLOUEZ, \
# DATE		RIPTION
DRAWN BY		DBS
SCALE		GRAPHIC
PROJ. NO.		7076A
DATE	09/28/15 - CO	NSTRUCTION DOCS
SHEET		L1

Andrew in in in in in in 100 to 11/01/15 04 02 12/01 01 101 01 01 00 00 00 100 '00 '01 '01 '01 '01 '02 '02 '02 '03' PHOTOMETRIC SITE PLAN



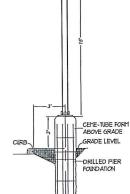

LOT LIGHT ELEVATION DETAIL



KWIK TRIP, Inc. P.O. BOX 2107 1826 OAK STREET LACROSSE, WI 54602-2107 PH (608) 781-8988 FAX (608) 781-8980

PLAN E 174

PHOTOMETRIC SITE PLA
CONVENIENCE STORE 17
WEBSTER AVENUE
ALLOUEZ WSCONSIN

-	$\circ$		-
NO PATE	DESCRIPTION		
	-		
DRAWN BY			CZE
SCALE		GRAP	HIS
PROJ. NO			1076A
DATE		03/	25/19

SHEET

CBOT

CZARNECK

ENGINEERIN

INCORPORAT

EINARNOCAT, SUIF B - WUKSEN, UI

WICE (1819 B- 1000 FAX (1819 B-1)

UED FACE: wucaragoon

FIXTURE QUANTITIES

PROVIDE A TOTAL OF (1) 15' POLES.

FIXTURE TYPES:

A - LIST LIGHTING: CRUS-SC-LED-SS-CW-UE-WHT
MOUNTING HEIGHT - 16"-0"

C - RECESSED LED DOUNLIGHT GOTHAM EVO-41/29-8AR-120-TRIJ

D - RAB LIGHTING: SLIMIZY

CALCULATION STATISTICS

B - LED STRIPLIGHT LITHONIA -T.LI-L96-LB840 MOUNTED IN GABLE HEIGHT: SEE ARCHITECTURAL ELEVATIONS

WALL MOUNTED LED FIXTURE
WALL MOUNT AT 9'-0" AFT TO TOP OF FIXTURE.

POLE MOUNTED AT A TOTAL HEIGHT OF 18'-0"

A RECESSED LED LIGHT MOUNTED UNDER CANOPY

E - LSI LIGHTING: XLCS-3-LED-SS-CUI-UE-LIHT

FIXTURE SYMBOLS:

C O RECESSED LED DOUNLIGHT

LED STRIP LIGHT






KWIK TRIP, Inc. P.O. BOX 2107 1626 OAK STREET LA CROSSE, WI 54602-2107 PH. (608) 781-8988 FAX (608) 781-8960


CONVENIENCE STORE #132
WEBSTER & GARLAND
ALLOUEZ, WI

# DATE	DESCRIPTION
	-
	-
DRAWN BY	B. BERG
SCALE	1/8" = 1'-0"
PROJ. NO.	0001
DATE	2015-10-07
SHEET	A201

SHEET NAME

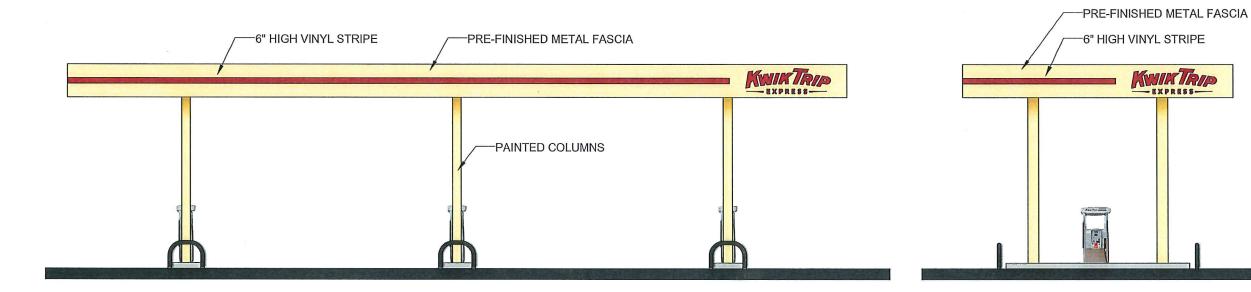

-6" HIGH VINYL STRIPE

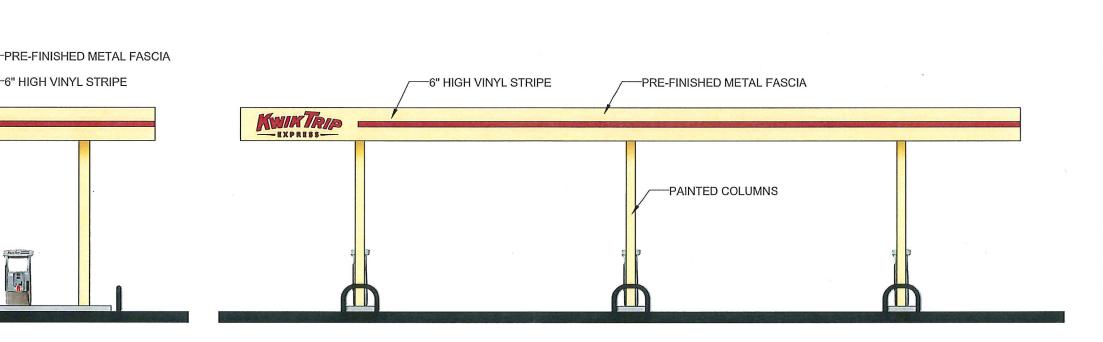



KWIK TRIP, Inc. P.O. BOX 2107 1626 OAK STREET LA CROSSE, WI 54602-2107 PH. (608) 781-8988 FAX (608) 781-8960

CONVENIENCE STORE #132 CANOPY ELEVATIONS WEBSTER & GARLAND ALLOUEZ, WI

# DATE	DESCRIPTION
	· ·
	-
	1
DRAWN BY	B. BERG
SCALE	1/8" = 1'-0
PROJ. NO.	000
DATE	2015-10-0
SHEET	A201