




BAYLAND BUILDINGS

P.O. BOX 13571 GREEN BAY, WI 54307
(920) 498-9300 FAX (920) 498-6033
www.baylandbuildings.com

DESIGN & BUILD GENERAL CONTRACTOR

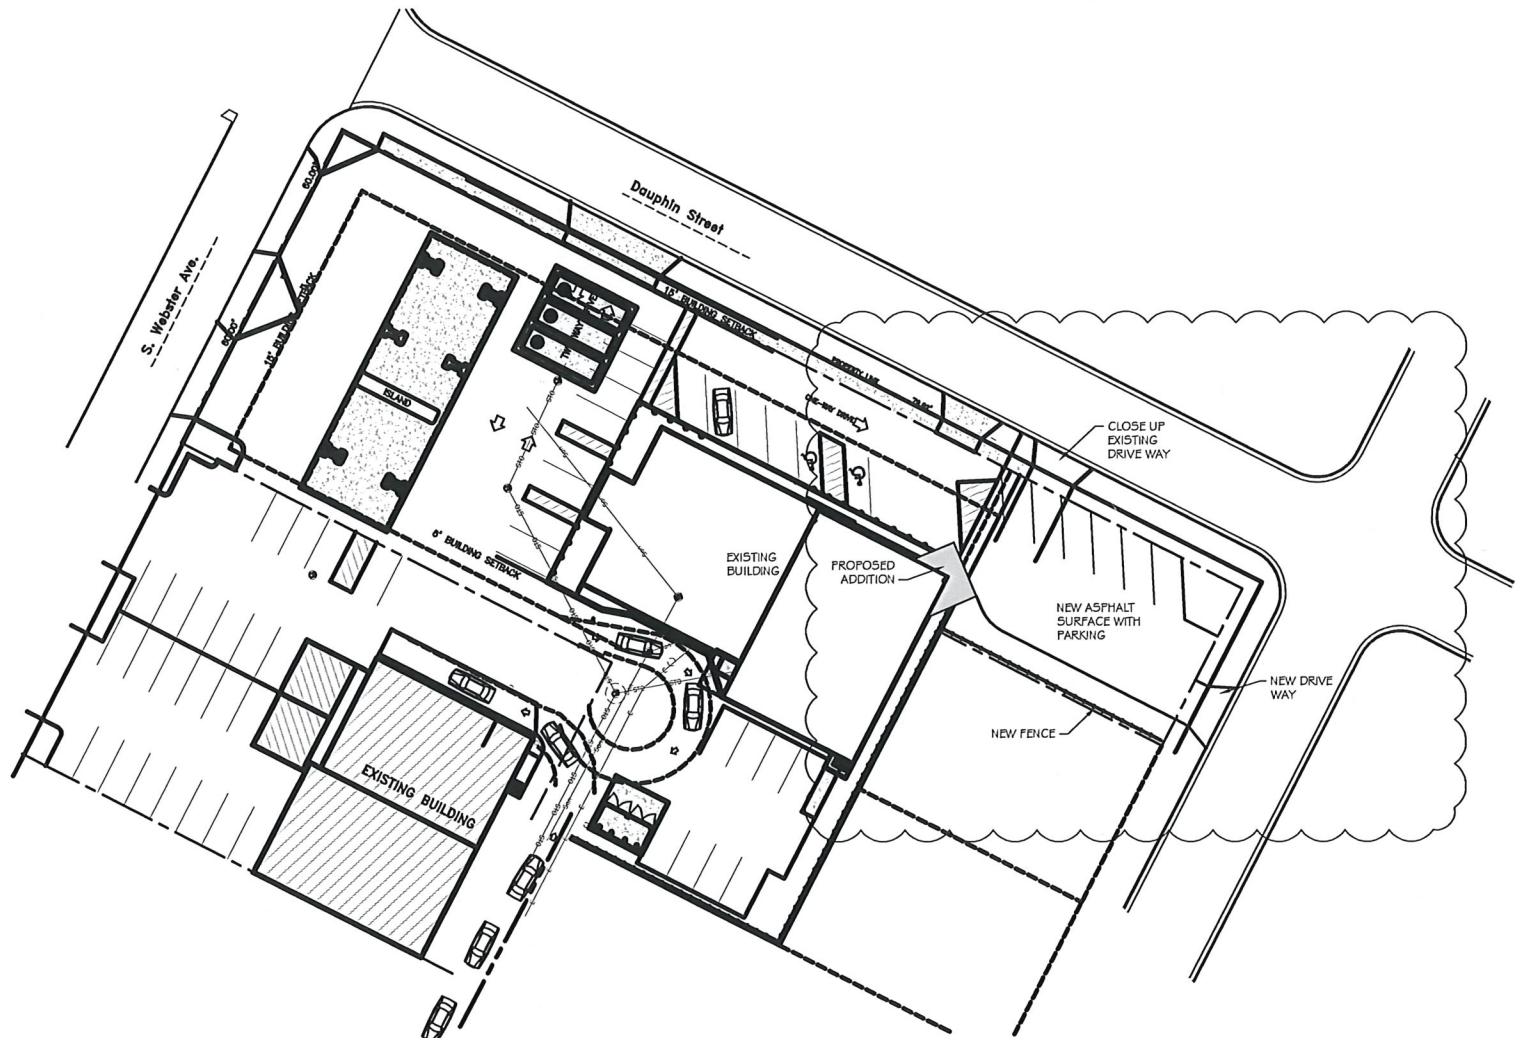

PROJECT INFORMATION

PROJECT: ALLOUEZ QUIK STOP
ADDRESS: 2203 WEBSTER AVE
VILLAGE OF ALLOUEZ, WI
USE: FUEL SALES, MERCANTILE & FOOD-"B" USE
ZONING: HIGHWAY USE & PROFESSIONAL OFFICE
OWNER: ALLEN MORIN
CONTACT: -

DESIGNERS OF RECORD:

ARCHITECT:
CONTACT:
GENERAL CONTRACTOR:
CONTACT: -

OCCUPANCY: SI & B NON-SEPARATED

PROJECT SUMMARY:

PROJECT CONSIST OF A NEW WOOD FRAMED BUILDING ADDITION WITH PULL BRICK EXTERIOR (FOR DRIVE-THRU)

THE BUILDING DOES NOT HAVE OR REQUIRE A FIRE SPRINKLER SYSTEM.

STORMWATER DISCHARGE FROM THIS LOT WILL REPLACE EXISTING ASPHALT TO DRAIN TO A NEW STORM SYSTEM WITH FILTERING CAPABILITIES

CONCEPTUAL SITE PLAN

DISCLAIMER: THE SITE INFORMATION PROVIDED IS BASED ON SOURCES BELIEVED TO BE RELIABLE AND IS SUBJECT TO CHANGE WITHOUT NOTICE. BAYLAND BUILDINGS INC. MAKES NO GUARANTEE, WARRANTY, OR REPRESENTATION AS TO THE ACCURACY AND COMPLETENESS OF SUCH INFORMATION.

APPROVED

OWNER'S SIGNATURE _____ DATE _____
SALES REPRESENTATIVE _____ DATE _____
(APPROVAL NOT VALID UNLESS SIGNED)

PROPOSED BUILDING FOR:

16-9437

, WISCONSIN; COUNTY OF:

SCALE VERIFICATION



NOTICE OF COPYRIGHT
THESE PLANS ARE COPYRIGHTED AND ARE SUBJECT TO COPYRIGHT PROTECTION AS AN ARCHITECTURAL WORK UNDER EEO, 102 OF THE COPYRIGHT ACT, 17 U.S.C. AS AMENDED DECEMBER 1990 AND KNOWN AS ARCHITECTURAL WORKS COPYRIGHT PROTECTION ACT OF 1990. THE PROTECTION INCLUDES BUT IS NOT LIMITED TO THE OVERALL FORM AS WELL AS THE ARRANGEMENT AND COMPOSITION OF SPACES AND ELEMENTS OF THE DESIGN. UNDER SUCH PROTECTION, UNAUTHORIZED USE OF THESE PLANS, WORK OR BUILDINGS REPRESENTED, OR LEGALLY RESULT IN THE CESSATION OF CONSTRUCTION OR BUILDINGS BEING SEIZED AND/OR MONETARY COMPENSATION TO BAYLAND BUILDINGS, INC.

JOB NUMBER: -

SALES REP:

LANCE VANDEN HEUVEL
(920) 371-8167

DRAWN BY:

DPO

DATE:

12-19-16

REVISIONS:

1 - -

ISSUED FOR:

- ☒ PRELIMINARY
☐ BID SET
☐ CONSTRUCTION

SHEET

C1.0

SITE PLAN

SCALE: 1" = 30'-0"



SCALE: 1" = 30'-0"