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Agenda Item	Number	 <i></i>

Memo

To: Village Board

Fr: Trevor Fuller, Planning and Zoning Administrator

Re: ACTION RE: PETITION FROM SURGERY CENTER OF GREEN BAY – SITE PLAN AND DESIGN REVIEW

ON PARCEL AL-2127, LOCATED AT 2825 S WEBSTER AVENUE

Date: 22 February 2017

Attached are the proposed plans submitted by the EV Acquisitions, LLC. for the site plan and design review of the proposed development of the Surgery Center of Green Bay at 2825 S. Webster Avenue (see attachments 1A, 1B). A representative from Ayres Associates will be present at the meeting to talk about the project and answer any questions.

Site Plan and Design Review Process

The site plan and design review process is an opportunity for the Village Board and the plan commission members to review and to ensure the plans meet village standards in regards to safety, efficiency, aesthetics, and legal concerns in a public forum. The village cannot consider the use of the parcel as part of the decision in this process, only review if the proposed development meets all site plan and design standards for this zoning district.

The proposed project is for parcels AL-2127, located at 2825 S. Webster Avenue. This parcel is zoned "C" Professional Office and Residence District" and the proposed use is allowed under this zoning classification. The plan commission is asked to review the Surgery center of Green Bay development proposal and determine if the proposed project meets the zoning and design requirements required by the zoning code for this proposed use.

Staff Comments and Recommendation

Staff has reviewed the proposed plans and has provided the representatives from EV Acquisitions, LLC. with comments (see attachments 2A, 2B, 2C, 2D).

Staff recommends the plan commission recommend approval of the petition by the Village Board, should all comments be addressed and necessary permits be filed prior to a final building permit being issued or a reasonable explanation (as determined by staff and the Village Board) as to why these comments were not addressed.

Plan commission is asked to recommend or not to recommend approval of the petition from EV Acquisitions, LLC., requesting a site plan and design review for a development on parcel AL-2127, located at 2825 S. Webster Avenue.

PROJECT NARRATIVE

Surgery Center of Green Bay Ambulatory Surgery Center

Village of Allouez, Wisconsin

Project Team:

Owner

EV Acquisitions, LLC C/O Titletown Law 222 Cherry Street Green Bay, WI 54301

Contact:

Cynthia Caine Trevelen

Phone:

920-435-9393

Email:

CTrevelen@titletownlaw.com

Civil Engineer

Ayres Associates 3376 Packerland Drive Ashwaubenon, WI 54115

Contact:

Craig Schuh, PE

Phone:

920-498-0970

Email:

SchuhC@AyresAssociates.com

Architecture

Sperides Reiners Architects, Inc. 4200 West Old Shakopee Road

Suite 220

Bloomington, MN 55437

Contact:

Nick Sperides

Phone:

952-996-9662

Email:

nick@sra-mn.com

Landscape Architecture

Sperides Reiners Architects, Inc.

Project Site Data:

The site is southeast of the intersection of Wisconsin Highway 172 and Webster Ave South. It is east of the Fox River. The site is 0.72-acres (31,562 SF) accessible from a private drive to the east of the site. Highway 172 is the nearest major connector to the north while downtown Allouez is the major node north of the site. The proposed building is in the center of the site with parking on the west and southeast parts of the site

Use:

The proposed building is an ambulatory surgical center (ASC) serves the Green Bay area with operating rooms and associated staff and patient areas. The ASC will house its operational areas on grade level in approximately 6,750 square feet. Its mechanical space will be placed in its attic space in approximately 1,300 square feet.

The design team is working to resolve a complete exterior material pallete with the owner. All materials will be compliant with Allouez Zoning Code 11.29 (9a). Contact architect for previous design study.

Light and light pollution

Parking lot standards will host full cut-off fixtures with less than .5 foot candles reaching the property line in any direction. Building mounted lighting includes full cut-off housings to eliminating glare and unwanted light wash. Architecturally integrated lights are added at the accessible entrances to provide path lighting.

Impact analysis

The ASC will benefit the community and provide a professional environment to care for health in the Green Bay area. Area activities will not be impacted. Its impact to utilities is depicted on the civil engineer's plans. Additionally, circulation is not impacted as the building sits within a buildable site; the street and parking circulation remain intact.

Impact to the surrounding land uses is positive. Surrounding uses include a correctional facility, an aquatic center, and orthodontic practices. These uses likely would benefit from having a state of the art surgical practice in their proximity.

Impact to the environment, noise, and community would also be positive. The ASC structure fills in a gap within the surrounding built-up neighborhood. The ASC weaves into the neighboring community with a hipped roof, high quality construction materials, and integrated mechanical space.

Sustainable Initiatives Summary

Sustainable initiatives are a priority in responsible design practiced and implemented by Sperides Reiners Architects. The ASC will have a variety of daylighting strategies, including building footprint dimensions that allow for the use of exterior windows directly into occupied waiting spaces. Additionally, the building will also integrate efficient systems and envelope designs to maximize its operational efficiencies and economics.

EV Acquisitions LLC C/O Titletown Law 222 Cherry Street Green Bay, WI 54301



Surgery Center of Green Bay Ambulatory Surgery Center Village of Allouez, Wisconsin

Stormwater Management Plan

The Surgery Center of Green Bay is proposing to build a new facility containing approximately 7,000 square feet of level floor space. Additionally, sidewalk and landscaping will be installed around the proposed building along with a generator and dumpster pad. No other site improvements are expected to take place with the exception of a bioretention area which will be constructed in the southwest corner of the site.

Per the Village of Allouez codes and ordinances, this site is exempt from meeting the total suspended solids (TSS) and total phosphorus (TP) reduction requirements for the Fox River TMDL along with peak discharge requirements. The proposed site does not have more than 20,000 square feet of impervious surface disturbance or more than one acre of total land disturbance. Although the site is not required to meet the listed reduction levels, the bioretention area serves as an appropriate best management practice (BMP) in order to reduce TSS and TP loading as well as peak discharges.

The bioretention area shall be maintained and warranted by the Contractor for a duration of two years after installation. Maintenance activities include; but are not limited to: erosion control repair, weed control, trash removal, plant replacements as necessary, biomass cutting and removal at the end of the season. Following the two-year warranty period, the property owners will accept all maintenance responsibilities.







SURGERY CENTER OF GREEN BAY

2825 S WEBSTER AVE ALLOUEZ, WI 54301

De Pere George St




Surgery Center Of Green Bay

TITLE SHEET

PROJECT NO: 16-06 DRAWN BY: E.M.

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SPERIODES REINERS ARCHITECTS, INC.
SUITE 220
SUITE 220
PH: 952.996,9662
FX: 952.996,9667
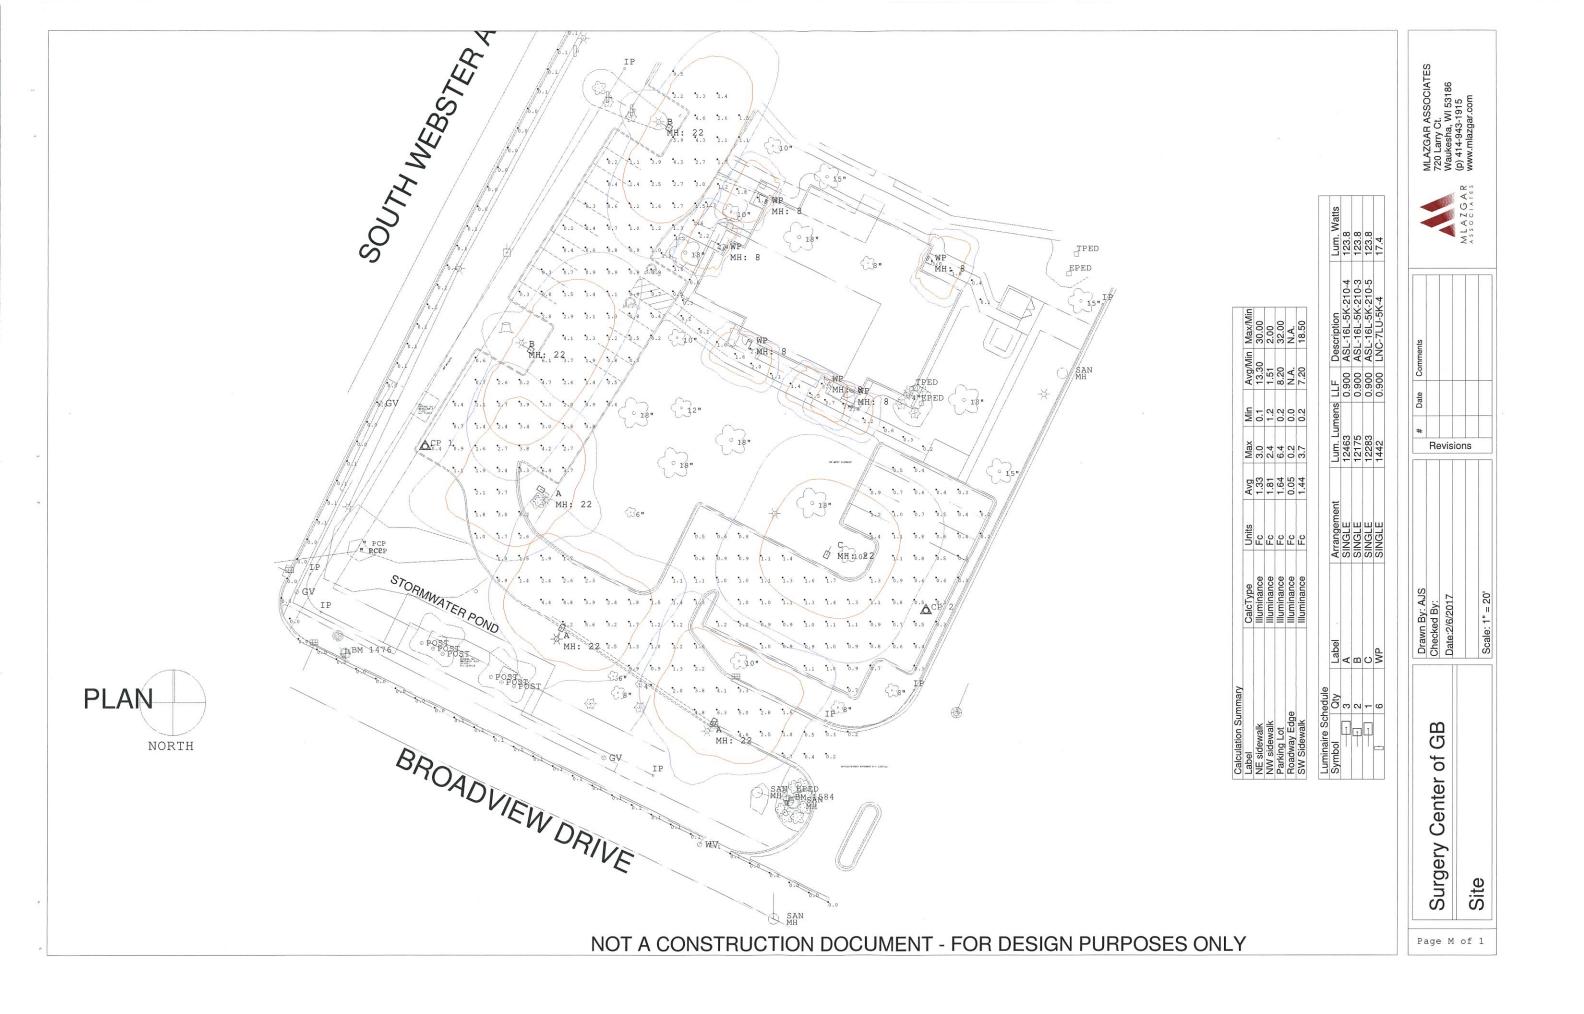
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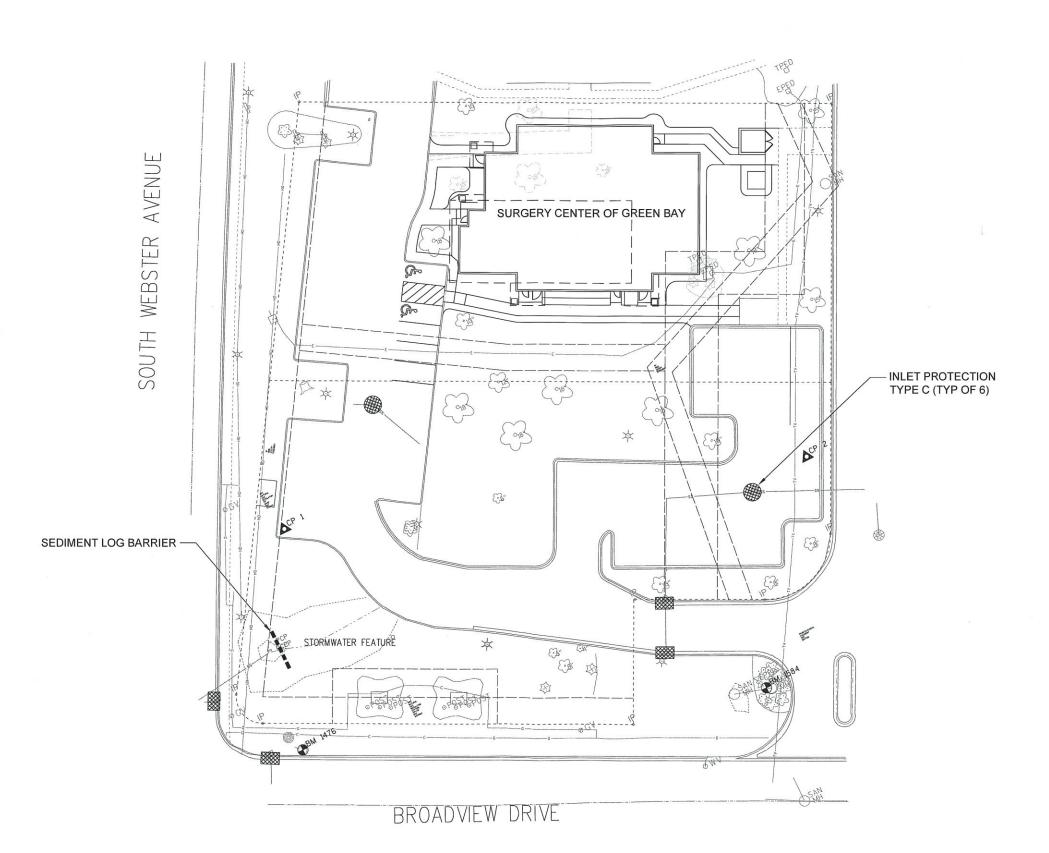
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SURGERY CENTER OF GREEN BAY 2825 S.WEBSTER AVENUE ALLOUEZ, WI 54301

PROPERTY IDENTIFICATION PLAN

PROJECT NO: 16-064 DRAWN BY: A.E. CHECKED BY: C.S.

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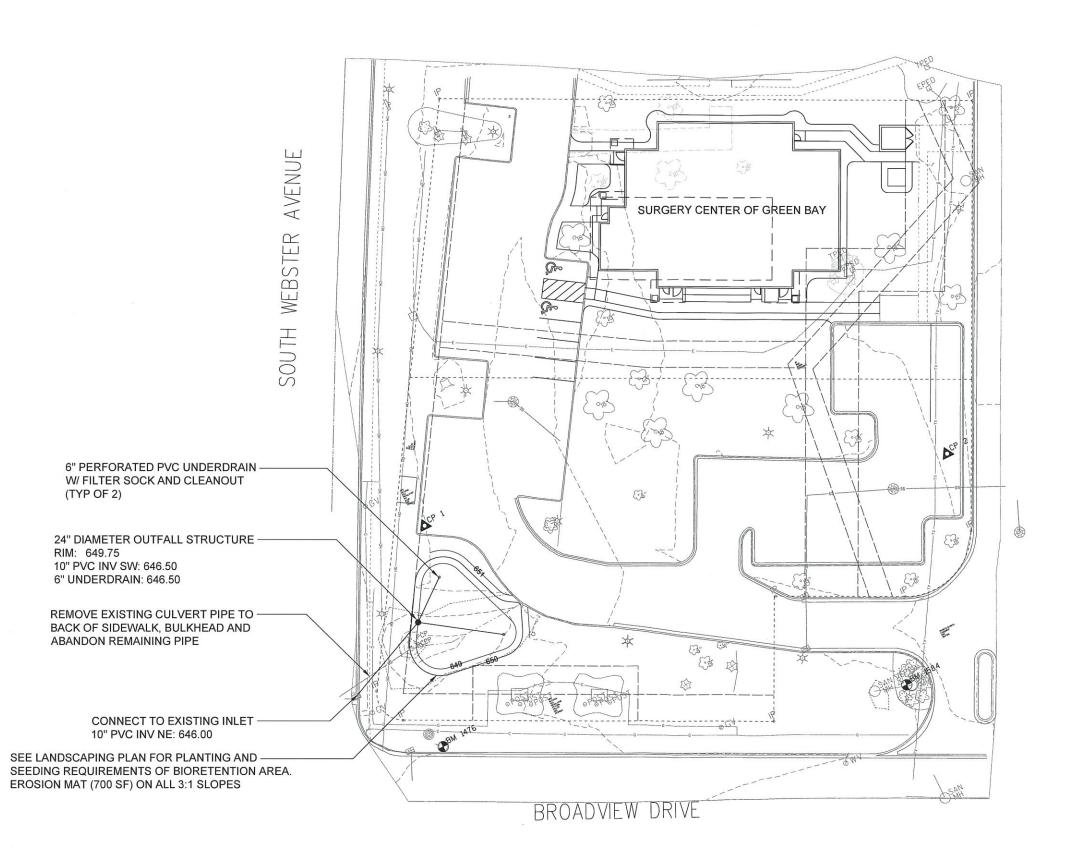
SURGERY CENTER OF GREEN BAY 2825 S.WEBSTER AVENUE ALLOUEZ, WI 54301

PROJECT NO: 16-064 DRAWN BY: A.E. CHECKED BY: C.S.

• EROSION CONTROL

PLAN

C2.0








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GRADING AND STORMWATER MANAGEMENT PLAN

PROJECT NO: 16-064 DRAWN BY: A.E. CHECKED BY: C.S.

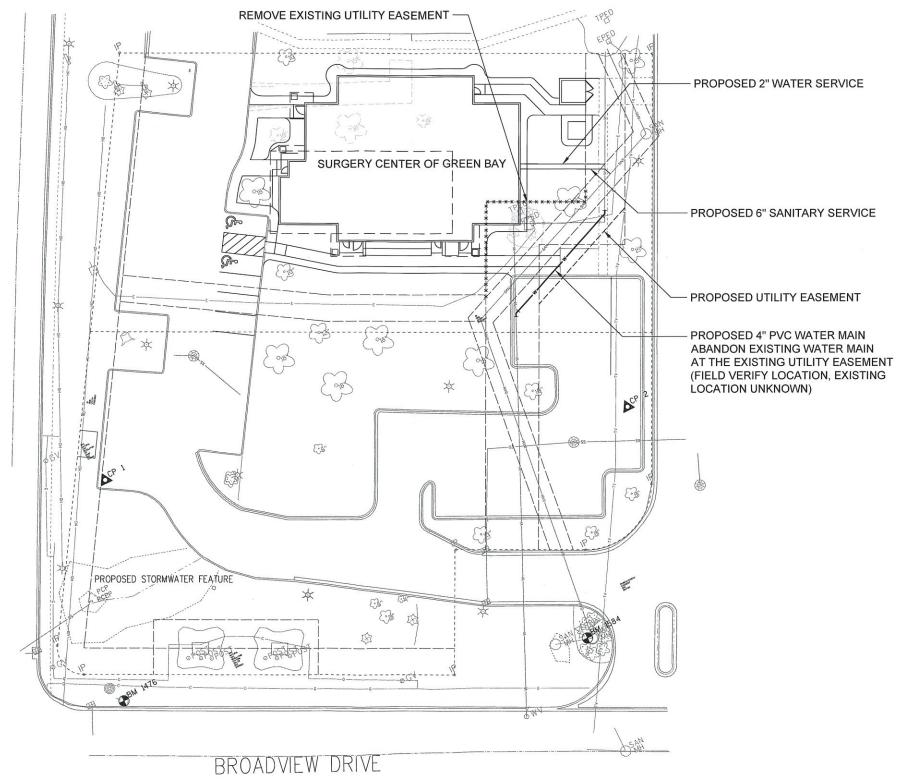

AVENUE

WEBSTER


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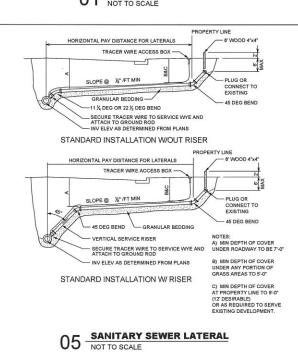
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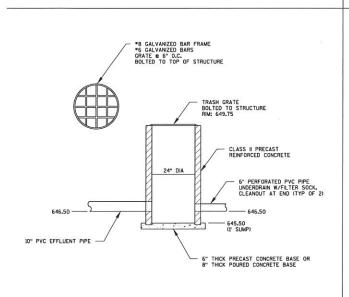
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• UTILITIES PLAN


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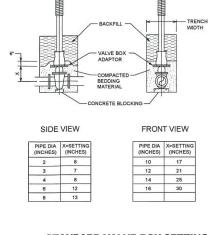


08 BIORETENTION OUTFALL STRUCTURE
NOT TO SCALE




OFFSET W/RESTRAINED JOINTS 02 (WATER MAIN AND FORCE MAIN) NOT TO SCALE

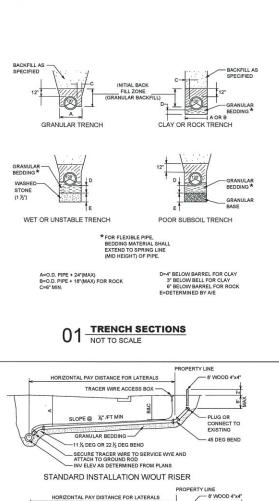INLET PROTECTION, TYPE A

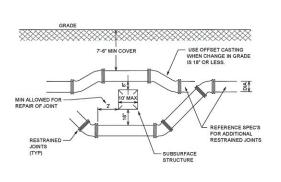


03 STANDARD VALVE BOX SETTING NOT TO SCALE

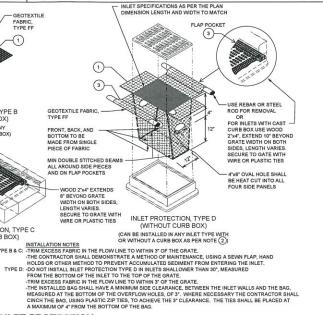


06 INLET PROTECTION NOT TO SCALE

INLET PROTECTION, TYPE B (WITHOUT CURB BOX) (CAN BE INSTALLED IN ANY INLET WITHOUT A CURB BOX)

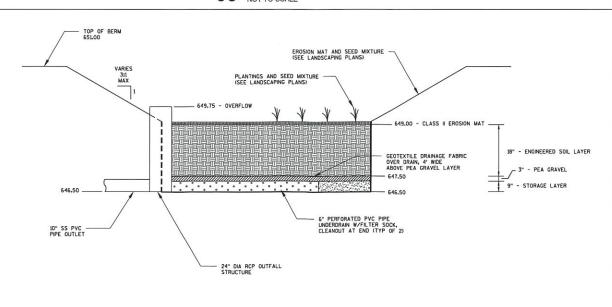


09 BIORETENTION DETAIL NOT TO SCALE

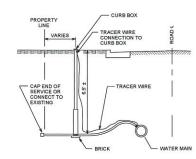

- TAP WATER MAIN ON 45° WITH PIPE. MINIMUM HORIZONTAL DISTANCE BETWEEN CORP STOPS SHALL BE 3-FEET.

WATER SERVICE INSTALLATION 04 WATER SER

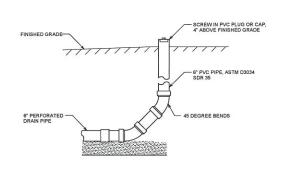

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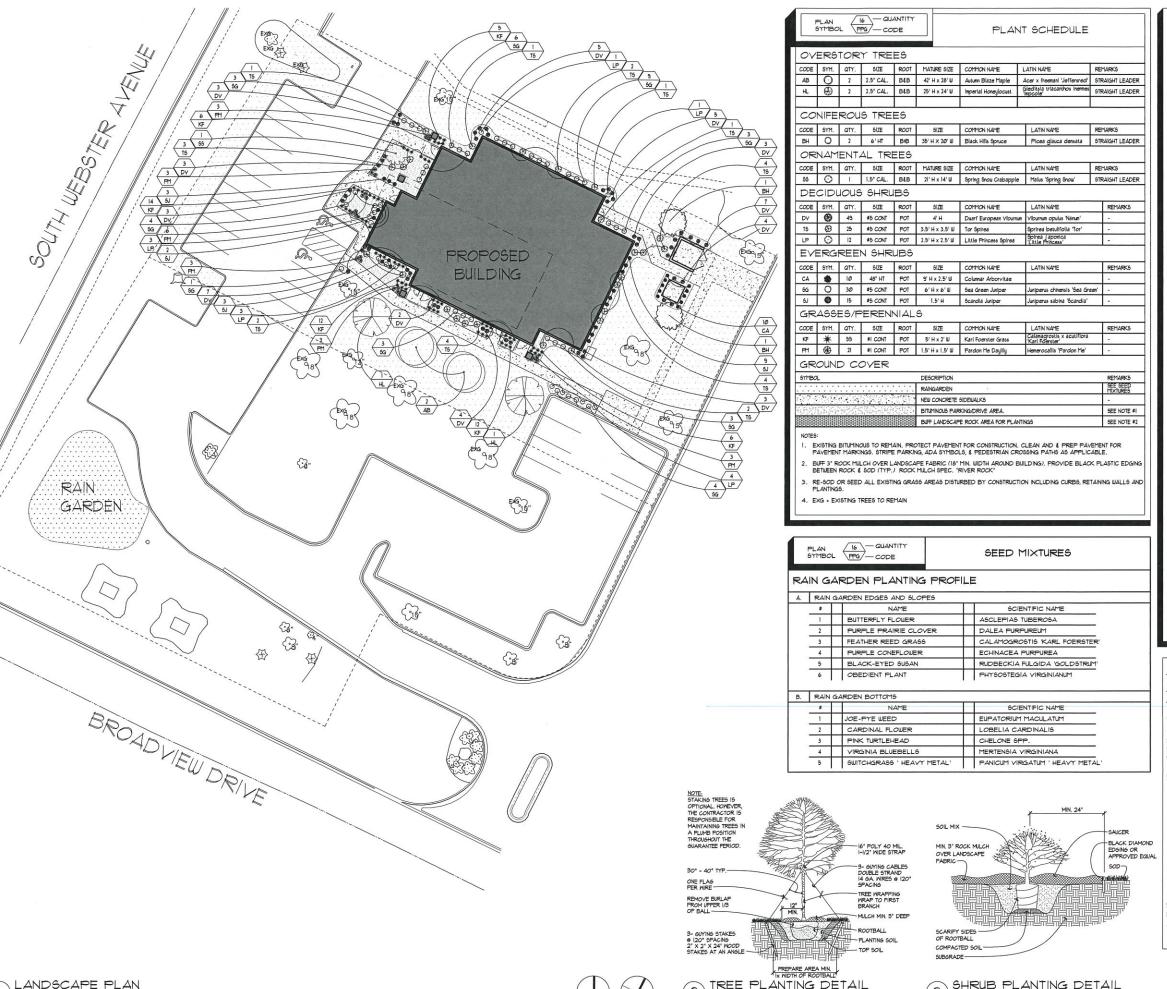


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CONSTRUCTION DETAILS

PROJECT NO: 16-064 DRAWN BY: A.E. CHECKED BY: C.S.



SCALE: I" = 20'-0"

TREE PLANTING DETAIL

LANDSCAPE NOTES

. ALL PLANTING IN TURF AREAS SHALL BE IRRIGATED WITH AN UNDERGROUND IRRIGATION SYSTEM, NO WATER IS ALLOWED ON ANY PAVEMENT, PARKING, WALKWAY OR BUILDING. THE IRRIGATION CONTRACTOR IS TO DESIGN AND SUBMIT SHOP DRAWING OF IRRIGATION DESIGN AND CALCULATIONS TO ARCHITECT FOR REVIEW PRIOR TO INSTALLATION, IRRIGATION DESIGN IS TO MEET ALL CITY PLUMBING CODES AND REQUIREMENTS.

2. EDGE ALL SHRUB AND PERENNIAL BEDS WITH SIX (6) INCH WIDE BY 1/8" THICK BLACK POWDER COATED GALVANIZED STEEL LANDSCAPE EDGING.

PROVIDE FOUR (4) INCH MINIMUM DEPTH OF SHREDDED HARDWOOD BARK MULCH IN FOUR (4) FOOT DIAMETER RING AROUND ALL TREES LOCATED IN TURF AREAS. NO VINYL EDGING IS REQUIRED FOR TREES LOCATED IN SHRUB AREAS AND SEEDING AREAS.

4. PROVIDE FOUR (4) INCH MINIMUM DEPTH OF SHREDDED HARDWOOD BARK MULCH IN ALL SHRUB AREAS.

PROVIDE THREE (3) INCH DEPTH OF SHREDDED HARDWOOD BARK MULCH IN ALL PERENNIAL

PROVIDE THREE (3) INCH DEPTH OF ONE AND ONE-HALF (1.5) INCH RIVER ROCK OVER BLACK LANDSCAPE FABRIC UNLESS OTHERWISE NOTED ON

LANDSCAPE CONTRACTOR IS RESPONSIBLE FOR FINISHED GRADING AND POSITIVE SURFACE DRAINAGE IN ALL LANDSCAPE AREAS. LANDSCAPE CONTRACTOR MUST ENSURE THAT THE FINAL GRADES ARE MET AS SHOWN ON GRADING PLAN. IF ANY DISCREPANCIES ARE FOUND, IMMEDIATELY NOTIFY ARCHITECT FOR RESOLUTION

8 ALL PLANT MATERIALS ARE TO CONFORM WITH STATE AND LOCAL CONSTRUCTION STANDARDS
AND THE CURRENT ADDITION OF THE AMERICAN ASSOCIATION OF NURSERYMEN STANDARDS. ALL PLANT MATERIALS ARE TO BE HEALTHY HARDY STOCK, AND FREE FROM ANY DISEASES, DAMAGE AND DISFIGURATION.

B. QUANTITIES OF PLANTS LISTED ON THE PLAN ARE TO GOVERN ANY DISCREPANCY BETWEEN THE QUANTITIES SHOUN ON THE PLAN SCHEDULE AND PLAN. PLACE PLANTS IN PROPER SPACING FOLLOWING LAYOUT FIGURES.

IN SOD SHOUN ON LANDSCAPE PLAN TO BE INSTALLED BY LANDSCAPE CONTRACTOR. SOD TO BE LAWN SOD, FREE OF WEEDS AND DISEASE. APPLY MINIMUM SIX (6) INCHES OF TOPSOIL AND THOROUGHLY FERTILIZE BEFORE LAYING SOD. LANDSCAPE CONTRACTOR TO MAINTAIN SODDED ARES IN HEALTHY CONDITION.

1. PLANTING SOIL FOR BACKFILLING TO BE TOPSOIL WITH 3 LBS. OF COMMERCIAL FERTILIZER AND ONE-FIFTH YARD OF PEAT HUMMUS PER CUBIC YARD, TOPSOIL TO BE SELECT TOPSOIL BORROW.

12. SPREAD PLANTING SOIL AT MINIMUM EIGHTEEN (18) INCH DEEP IN ALL PERENNIAL BEDS PRIOR TO

3. FOLLOW LANDSCAPE DETAILS FOR ALL INSTALLATION, UNLESS OTHERWISE NOTED

14. LANDSCAPE CONTRACTOR TO MAINTAIN PLANTS SEASONS FROM DATE OF PROVISIONAL ACCEPTANCE UNTIL FINAL ACCEPTANCE.

LANDSCAPING:

VILLAGE OF ALLOUEZ ZONING CODE 11.29 (10-8) AT LEAST 20 PERCENT OF THE TOTAL LOT AREA SHALL REMAIN OPEN SPACE

31,562 SF 1,050 SF / 22% TOTAL PARCEL AREA: BUILDING AREA: PAVEMENT AREA: 10,752 SF / 34% 13,760 SF / 44% GRASS & LANDSCAPED AREA:

REQUIRED LANDSCAPE ONE (1) TREE PER DUELLING UNIT.

ONE (1) TREE PER 1,000 SQUARE FEET OF GROSS FLOOR AREA, AND ANY FRACTION THEREOF, FOR (8060 ÷ 1000 = +8)

ONE (1) TREE PER EVERY EIGHT (8) PARKING STALLS.

(20 + 8 = +2.5) (+2.5 FOR PARKING SOUTH OF SITE) ONE (I) STREET TREE FOR STREET FRONTAGES GREATER THAN 100 FEET. (127 LF FRONTAGE = +1) (TOTAL 15 TREES REQUIRED)

PROVIDEDED LANDSCAPE

SHRUB PLANTING DETAIL

3 SHRUB I

5 TREES (+13 EXISTING SOUTH OF SITE)

EXISTING: ADDITIONAL: 7 TREES


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 LANDSCAPE PLAN



GENERAL SITE PLAN NOTES:

- BEARING, DIMENSIONS, AND EASEMENTS SHOWN HEREON ARE FOR REFERENCE ONLY. REFER TO PROJECT ALTA/ASCH LAND TITLE SURVEY FOR PROPERTY LEGAL DESCRIPTION AND VERIFICATION OF REFERENCED INFORMATION
- G.C. TO COORDINATE ALL DIMENSIONS WITH SURVEY AND CIVIL DRAWINGS, NOTIFY ARCHITECT / ENGINEER OF ANY DISCREPANCIES
- ALL AREAS NOT OTHERWISE NOTED SHALL BE LANDSCAPED. REFER TO THE LANDSCAPE PLANFOR ADDITIONAL INFORMATION SHALL BE LANDSCAPED. COORDINATE THE PHASES OF CONSTRUCTION AND PLANTING INSTALLATIONS WITH OTHER CONTRACTORS WORKING ON SITE
- EXISTING TREES SHALL BE PROTECTED AND SAVED UNLESS NOTED TO BE REMOVED AND/OR ARE IN AN AREA TO BE GRADED. PROTECT TREES WITH FENCING WHERE CAPABLE PLACE AT THE DRIP LINE OF THE TREE. HAINTAIN CLEARANCE FOR CITY STREET SNOW REMOVAL. ANY CLESTION REGARDING WHETHER PLANT THATERAL SHOULD REMAIN OR NOT SHALL BE BROUGHT TO THE ATTENTION OF THE ARCHITECT PRIOR TO REMOVAL.
- THE CONTRACTOR SHALL CONTACT ALL PUBLIC UTILITIES FOR LOCATIONS OF ALL THE CONTRICTION SHALL CONTACT ALL PUBLIC WILLIES FOR EXCLATIONS OF ALL UNDERGRADAD WIRES, CALLES, CONDUITS, PIPES, MANOLES, VALYS, OR OTHER BURIED STRUCTURES BEFORE DIGGING. <u>CONTACT DIGGERS HOTING.</u> (880) 124-881]. CONTRACTOR SHALL REPAIR OR REPLACE THE ABOVE WHEN DAYMAGED. ALL ROADBUAY PACEPINT, SIDEWALK, AND CURB & GUITTER REMOVED DURING UTILITY INSTALLATION SHALL BE REPLACED WITH EQUIVALENT SECTIONS AS REQUIRED. ANY WORK DONE TO SIDEMALKS AND CURBS WITHIN THE PUBLIC RIGHT OF WAY MUST BE DONE TO CITY STANDARDS AND SPECIFICATIONS
- ANY DAMAGE TO ADJACENT SIDEWALKS, CURBS, OR PAVEMENT MUST BE REPAIRED TO MATCH MATERIALS OF CURRENT CONDITION
- ALL EXISTING CONDITIONS SHALL BE REMOVED AS REQUIRED TO ACCOMMODATE PROPOSED CONSTRUCTION, WHETHER OR NOT NOTED ON DEMOLITION PLAN.
- PROVIDE A SAFE PASSAGE THROUGH AND/OR AROUND CONSTRUCTION SITE AS REQUIRED. COORDINATE WITH EXISTING NEIGHBORING PROPERTY MANAGERS AND VILLAGE STAFF AS REQUIRED

DEMOLITION KEYED NOTES:

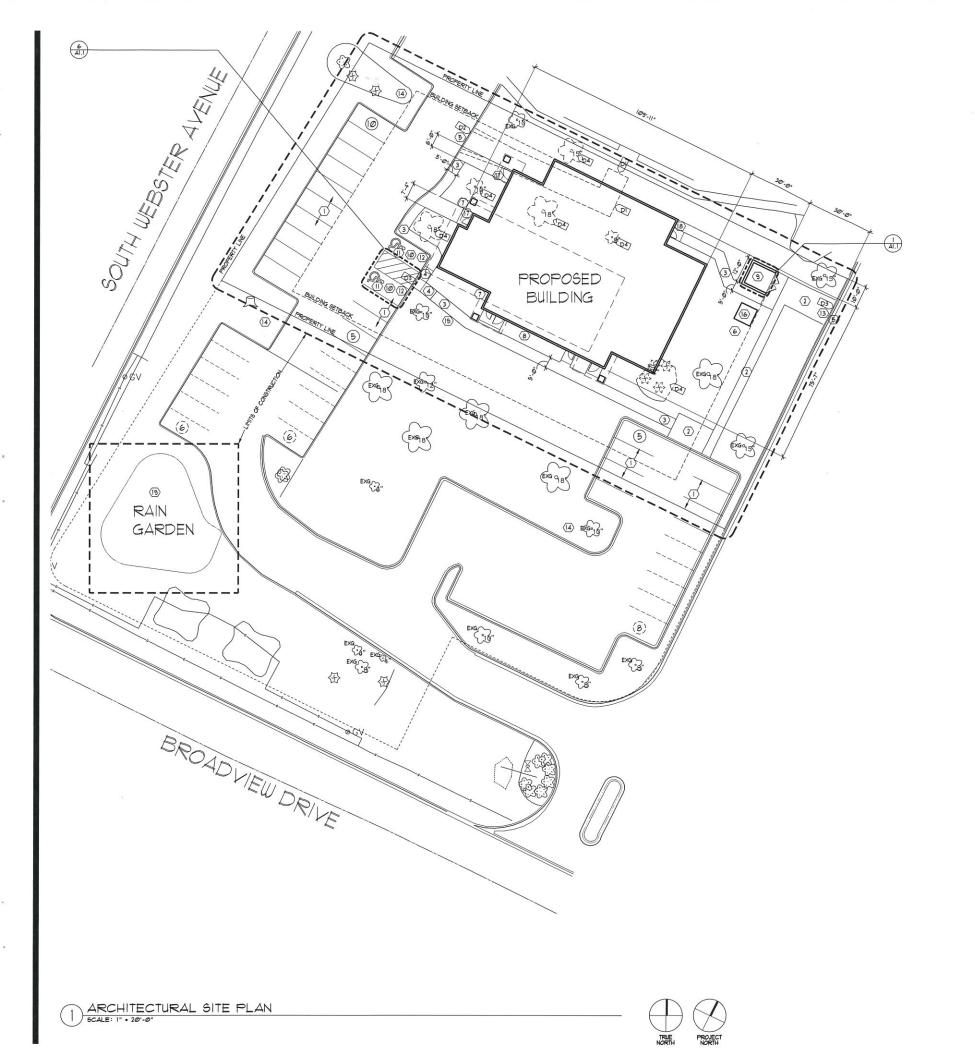- DI SAWCUT SIDEWALK AND REMOVE.
- D2 REMOVE CURB AND GUTTER.
- D3 SLOPED CONCRETE FLATILORK.
- D4 EXISTING TREES TO BE REMOVED.

SITE PLAN KEYED NOTES:

- (I) EXISTING ASPHALT PAVING, TO REMAIN. RESTRIPE PAVMENT AS REQUIRED.
- 2 EXISTING CONCRETE WALK, TO REMAIN.
- $\begin{picture}(40,0)\put(0,0){\line(1,0){100}}\put(0,0)$
- ACCESSIBLE RAMP W DETECTABLE WARNING ALONG ACCESSIBLE ROUTES (TYP.). SLOPE TO BE GREATER THAN 1:20 AND NO STEEPER THAN 1:12.

 CONCRETE CURB. SEE CIVIL FOR LOCATIONS & DETAILS.

- (6) PAD MOUNTED TRANSFORMER WITH BOLLARDS, (COORDINATE W/ P.A., ANY OTHER LOCATIONS).
- 7) PROJECTED BUILDING OVERHANG, ABOVE (SHOWN DASHED).
- (8) GAS METER. COORDINATE WITH MECHANICAL.
- (9) REFUSE AND RECYCLING ENCLOSURE.
- $\begin{tabular}{ll} $$ \triangle CESSIBLE PARKING SPACES AND THEIR ACCESS AISLES \\ $$ SHALL BE I 1/2\% (2\% MAX.) $$ LOPE IN ALL DIRECTIONS. \\ \end{tabular}$
- (II) PAINTED ACCESSIBLE PARKING SYMBOL TO MEET ALL GOVERNING CODES.
- (12) ACCESSIBLE PARKING SIGN AT ALL ACCESSIBLE STALLS.
- (13) CONFIRM SLOPE AT PAVEMENT WITH TRASH COMPANY.
- (4) LIGHT POLE (TYPICAL). QUANTITY AND LOCATION OF POLES TO BE DETERMINED BY APPROVED PHOTOMETRICS.
- (15) BIKE RACK, DERO ROLLING RACK RR2H OR EQUAL. COLOR: TBD.
- $\begin{tabular}{ll} \hline \end{tabular}$ Emergency generator, coordinate with electrician and medical equipment supplier.
- (IT) AUTOMATIC DOOR OPERATOR SWITCH ON SQUARE BOLLARD POST, MINIMM 5"X5".

 BOLLARD TO BE SWEFACE-MOINTED TO OUTSIDE EDGE OF CONCRETE STOOP, BOLLARD TO BE FINISHED TO MATCH BUILDING EXTERIOR MATERIAL. SEE ENLARGED FLOOR PLAN AND DOOR HARDWARE.
- (18) PRELIMINARY MEDGAS LOCATION. COORDINATE WITH MEDICAL EQUIPMENT SUPPLIER.
- (19) RAINGARDEN. SEE CIVIL DRAWINGS FOR GRADING AND UTILITIES.

PARKING REQUIREMENTS:

PROPOSED BUILDING FOOTPRINT AREA = 6.760 SQ. FT. BUILDING AREA W MEZZANINE = 8.060 SQ. FT. FARKING REQUIRED = 1 PER 200 SQ. FT. = 40 STALLS PARKING PROVIDED: 40 STALLS IN VICINITY CONFORMS TO VILLAGE OF ALLOUEZ ZONING 11.13 (K) SHALL RECEIVE ONE SPACE FOR EACH 200 SF OF FLOOR AREA

ADA PARKING SPACES: & VAN ACCESSIBLE = 2 SPACES PROVIDED

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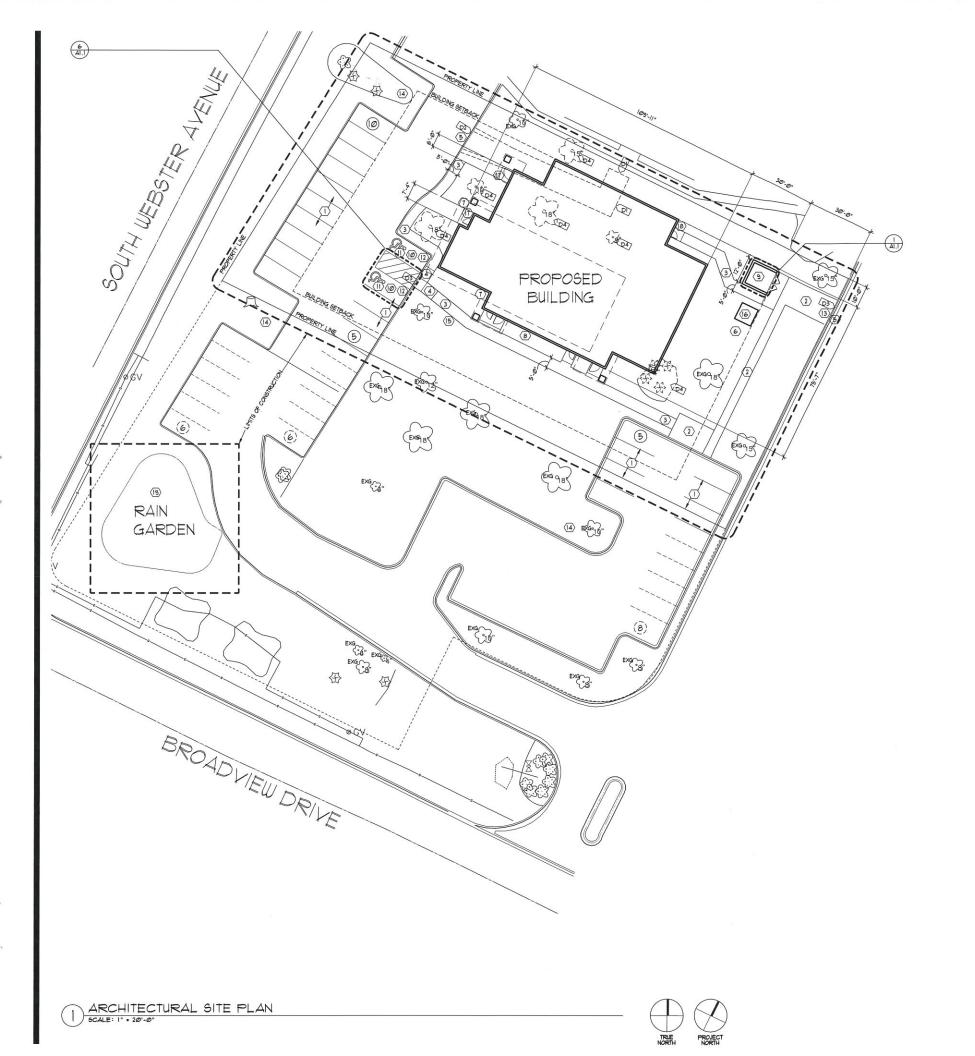
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JERY CENTER

OF GREEN BAY
2825 S.WEBSTER AVENUE
ALLOUEZ, WI 54301

 ARCHITECTURAL SITE PLAN

PROJECT NO: 16-064 DRAWN BY: E.M. CHECKED BY: N.S.



GENERAL SITE PLAN NOTES:

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- D2 REMOVE CURB AND GUTTER.
- D3 SLOPED CONCRETE FLATWORK.
- D4 EXISTING TREES TO BE REMOVED.

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- (19) RAINGARDEN. SEE CIVIL DRAWINGS FOR GRADING AND UTILITIES.

PARKING REQUIREMENTS:

PROPOSED BUILDING FOOTPRINT AREA = 6,760 SQ. FT. BUILDING AREA W/ MEZZANINE = 8,060 SQ. FT. PARKING REQUIRED = 1 PER 200 SQ. FT. = 40 STALLS PARKING PROVIDED = 40 STALLS 20 STALLS ON SITE & 20 STALLS IN VICINITY CONFORMS TO VILLAGE OF ALLOUEZ ZONING 11.13 (K)
SHALL RECEIVE ONE SPACE FOR EACH 200 SF OF FLOOR AREA

ADA PARKING SPACES: & VAN ACCESSIBLE = 2 SPACES PROVIDED


PRELIMINARY NOT FOR CONSTRUCTION

999999

JE GREEN BAY
SS SWEBSTER AVENUE
OUEZ, WI 54301 SURGERY Q

> ARCHITECTURAL SITE PLAN

PROJECT NO: 16-064 DRAWN BY: E.M. CHECKED BY: N.S.

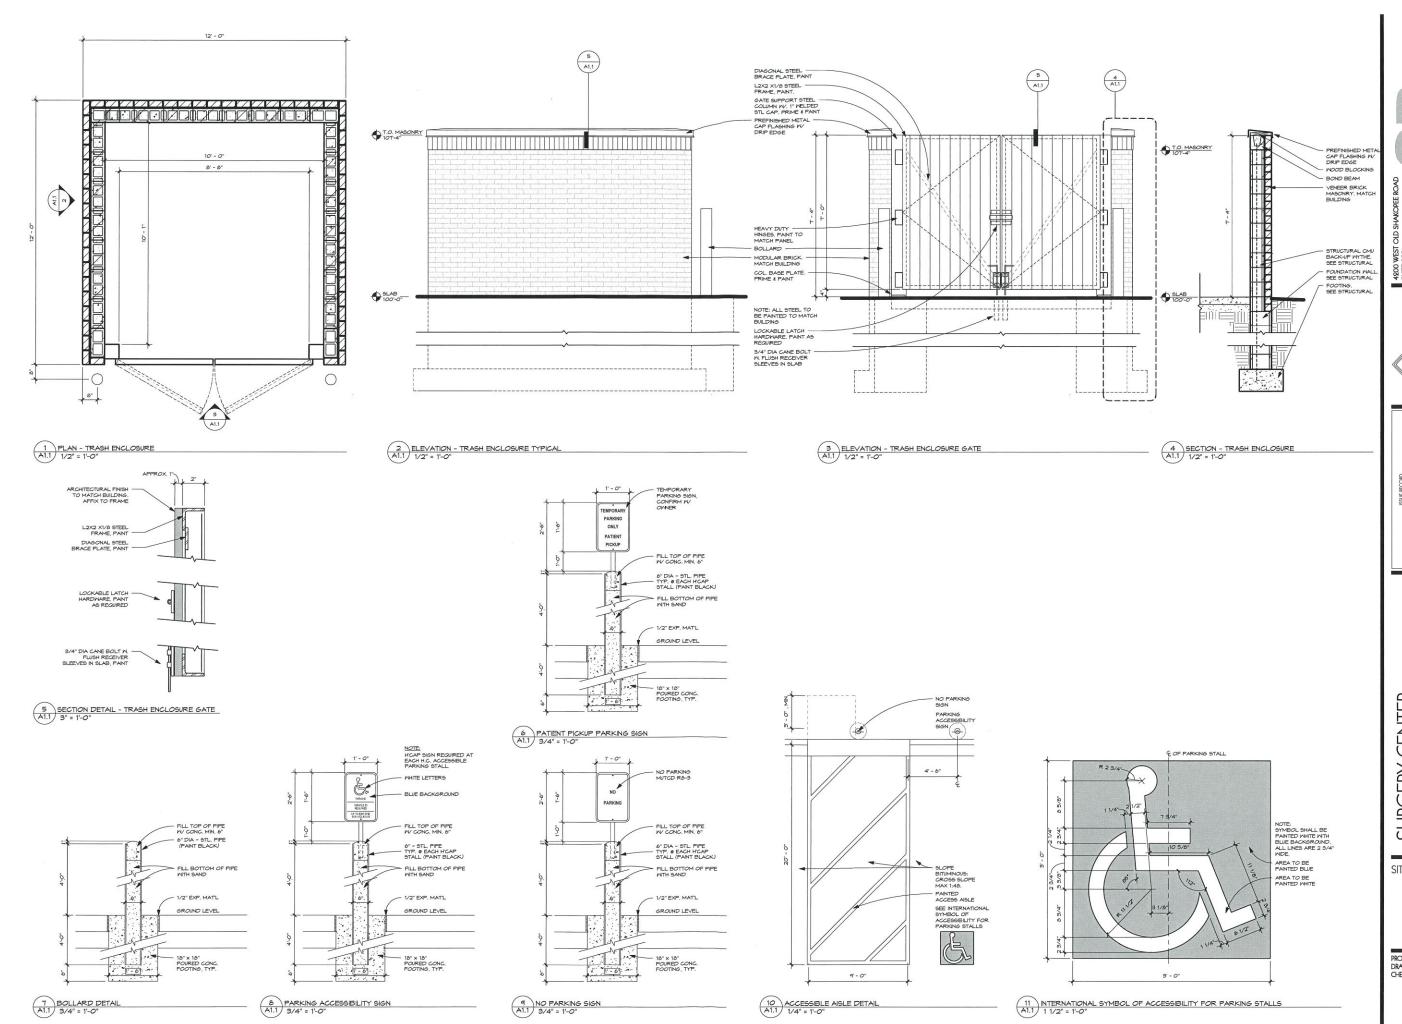

4900 WEST OLD SHAKOPEE ROAD
SUITE 280
BLOOMINGTON, MINNESOTA 55437
PRIL 592-906-9063
WWW,SRA-MINLCOM
GCOPMENT 8017
SPERIDES REINERS ARCHITECTS, INC.


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11.0.2017 | GENERATION | G

SURGERY CENTER OF GREEN BAY

SITE PLAN DETAILS

PROJECT NO: 16-064 DRAWN BY: E.M. CHECKED BY: N.S.

A1.1

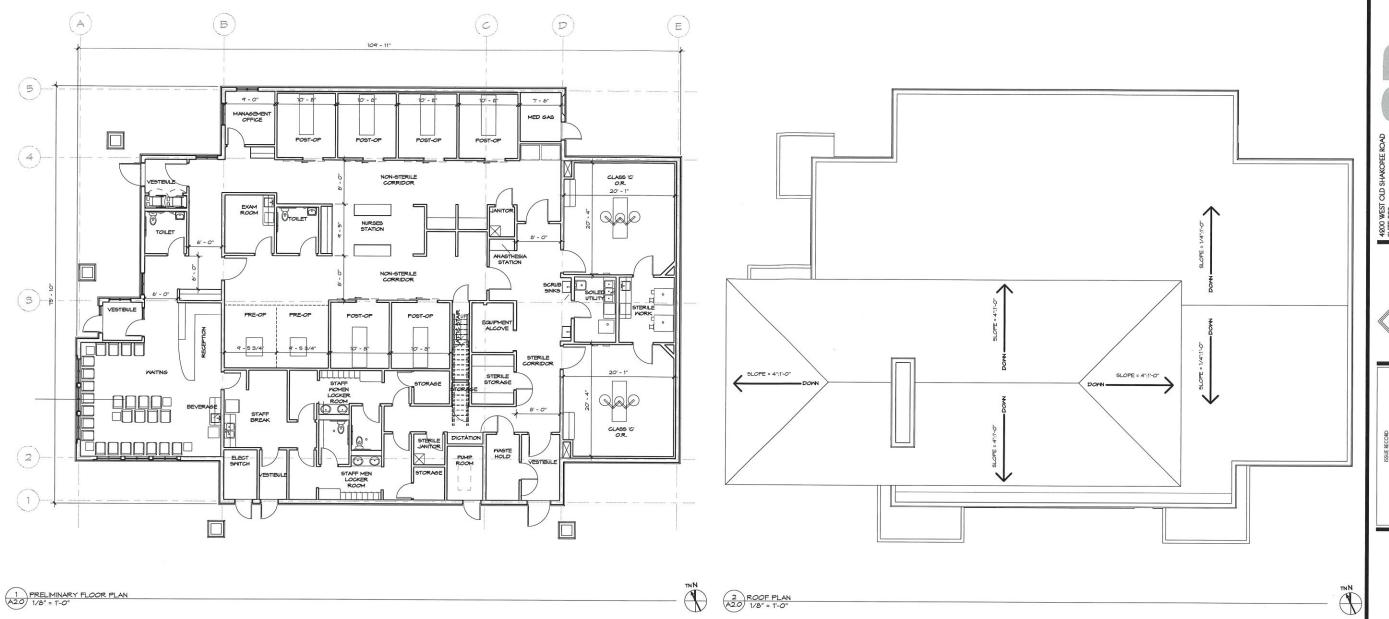


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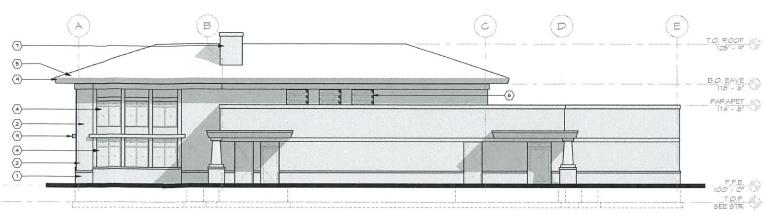
Surgery Center Of Green Bay

PRELIMINARY PLANS

PROJECT NO: 16-064 DRAWN BY: E.M. CHECKED BY: N.S.


A2.0




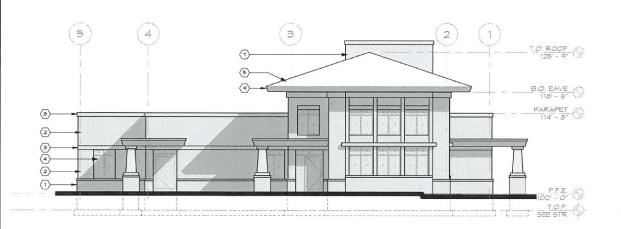

1 WEST ELEVATION A3.0 1/8" = 1'-0"

2 SOUTH ELEVATION A3.0 1/8" = 1'-0"

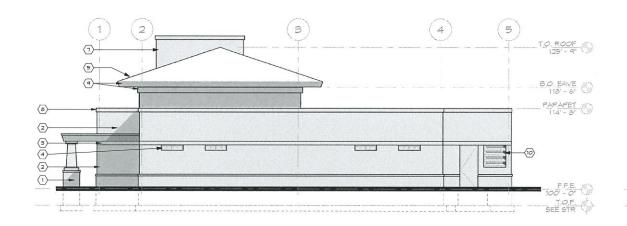

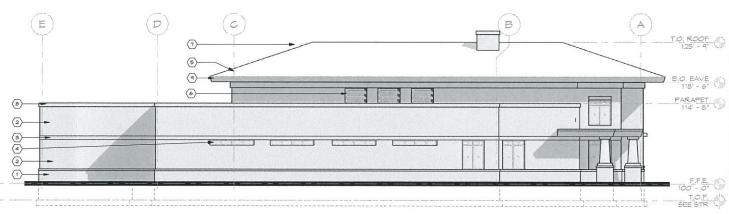

3 EAST ELEVATION A3.0 1/8" = 1'-0"

4 NORTH ELEVATION A3.0 1/8" = 1'-0"

EXTERIOR ELEVATION KEYNOTES

ALL MATERIAL TO COMPLY WITH ALLOUEZ ZONING CODE 11.29 (9A)

- (1) WALL BASE MATERIAL STONE.
 TYPE, COLOR, & PATTERN TO BE DETERMINED
- 2 EXTERIOR MALL FINISH #1. TYPE, COLOR, & PATTERN TO BE DETERMINED
- 3 EXTERIOR WALL FINISH #2.
 TYPE, COLOR, & PATTERN TO BE DETERMINED
- ALIMINIM STOREFRONT SYSTEM.
 COLOR TO BE DETERMINED.
- (5) ROOF SHINGLES. COLOR TO BE DETERMINED.
- (6) PREFINISHED METAL MECHANICAL LOUVERS.
- (7) MECHANICAL VENT STACK, TO MATCH WALL BASE MATERIAL
- PREFINISHED METAL ROOF EDGE.
 COLOR TO BE DETERMINED
- PREFINISHED METAL FASCIA.
 COLOR TO BE DETERMINED
- (10) MEDGAS ACCESS PANEL.

SURGERY CENTER OF GREEN BAY

ELEVATIONS

PROJECT NO: 16-064 DRAWN BY: E.M. CHECKED BY: N.S.

A3.0

Site Plan & Design Review – Staff Comments

Site:

2825 S Webster Avenue (Parcel AL-2127)

Development: Surgery Center of Green Bay

Developer:

Sperides Reiners Architects, Inc.

Ayres Associates

Zoning Department review:

Zoning district		"C" Professional Office and Residence District				
Building use (allowed)		Medical Office/Clinic				
		Required	Provided	Notes		
Height		Lesser of 40' or 3 stories	Not provided			
Lot Area Frontage Green space	7,500SF	31,562SF				
	100'	127.25'	Measurement based on Brown County aerials. Should be noted on plans.			
	20%	44%				
Side Side	Front	50'	72'	Calculation based on Brown County aerials. Should be noted on plans.		
	Side (inner)	10'	10'			
	Side (corner)	N/A	N/A			
	Rear	30'	60'			
Parking Number Size Bicycle	Number	1.5/200SF + 1per employee on shift: 44	21 (on site)	Additional 28 stalls on adjoining parcel. Perpetual parking easement agreement betwee parcels should be established.		
	Size	10'x20'	Not provided	Stall size is allowed regardless if existing kept.		
	Bicycle	Bicycle parking should be provided	Standards met	Recommend a bicycle rack which accommodate a U-shaped lock and the ability to secure the bik frame and both wheels instead of proposed. Also maintain the rack out of the pedestrian zone.		
Access	Automobile	24' drive lanes with 90 degree parking	Not provided	Perpetual ingress/egress easement agreement between parcels should be provided. Lane width is allowed regardless if existing kept.		
	Pedestrian	ADA compliant sidewalks	Standards met	Sidewalk widths should be noted on plans. Pedestrian access from Webster Avenue or Broadview Drive is recommended.		
Architecture		Varied rooflines and other architectural designs that break-up the building mass	Standards met			
Exterior f	inishes	Brick, stone, glass, fiber cement siding, EFIS, stucco, wood siding	Not provided			
Lighting		Dark sky compliant, no light directed towards ROW, no more than 0.5FC at property line, must be shut off at 10p.m.	Standards met	There is a slight spillage of more than 0.5FC onto neighboring drive, which is acceptable. Staff recommends the full site lighting option.		
Sign		N/A	N/A	Location should be identified, but design is reviewed at time of sign permit. Sign should be shut off at 10p.m. with lights.		
Fences/Screening		No fences or berms are required, dumpster must be located at rear and be screened using same finishes as primary structure, mechanical equipment must be screened from street	Standards met, except for back-up generator	Back-up generator should be screened from view of the street to the greatest extent possible.		

^{**}All other zoning requirements for "C" Professional Office and Residence District stipulated in Chapter 475 of Village Ordinances should be met to the highest degree possible.

- Fire Department review:
 - The building will have a full NFPA 13 sprinkler system according to the architect.
 - Additional comments attached (Attachment 2B).
- Parks, Recreation, and Forestry Department review:
 - Comments attached (Attachment 2C).
- Public Works Department review:
 - Comments attached (Attachment 2D).
- Additional comments:
 - Location of construction access shared drive shall remain accessible and discussion should be considered for maintenance of shared roadway.

Date Reviewed:

February 22, 2017

Comments Submitted By:

Trevor Fuller, Village of Allouez Planning & Zoning Administrator



Fire Department

Fire Marshals Division Captain Joe Gabe

February 16th 2017,

Trevor Fuller-Planning and Zoning Administrator Village of Allouez 1900 Libal Street Green Bay, WI 54301-2453

RE: Site Plan Reviewer comments for the new Surgery Center of Green Bay located at 2825 South Webster Ave.

Dear Mr. Fuller,

Attached are the GBMFD requirements for the new Surgery Center of Green Bay located at 2825 South Webster Ave.

- GBFD requires that all exterior FDC (Fire Department Connections) and Standpipe
 connections are five inch Storz brand connections. If the FDC or Standpipe connection is
 higher than 30 inches above finished grade, then you will be required to install a thirty
 three down degree angle connection on the five in Storz connection to prevent hose
 kinking in the five inch supply line to the fire department connection. IFC 903.3.7.
- GBFD will require a Knox Box brand lock box at the Main entrance of the buildings. If
 the building contains a sprinkler control room that is accessed from the exterior a Knox
 box must also be placed adjacent to that door. The Knox Box brand locking boxes can be
 purchased by visiting the Knox Box website or calling (920) 448-3280 and requesting a
 Knox Box brand locking box packet. IFC #506.1 and 506.1.1.
- The parking lot and fire lane roads shall meet the minimum weight and turning radius for GBMFD apparatus (See Attached Specifications Sheets) IFC 503.2

If you have any questions please feel free to contact the Green Bay Fire Metro Marshal's Office at (920)448-3289.

Respectfully,


Captain Joe Gabe Fire Marshal's Office

Green Bay Fire Department

P. Tun

Phone-(920)448-3289

joega@greenbaywi.gov

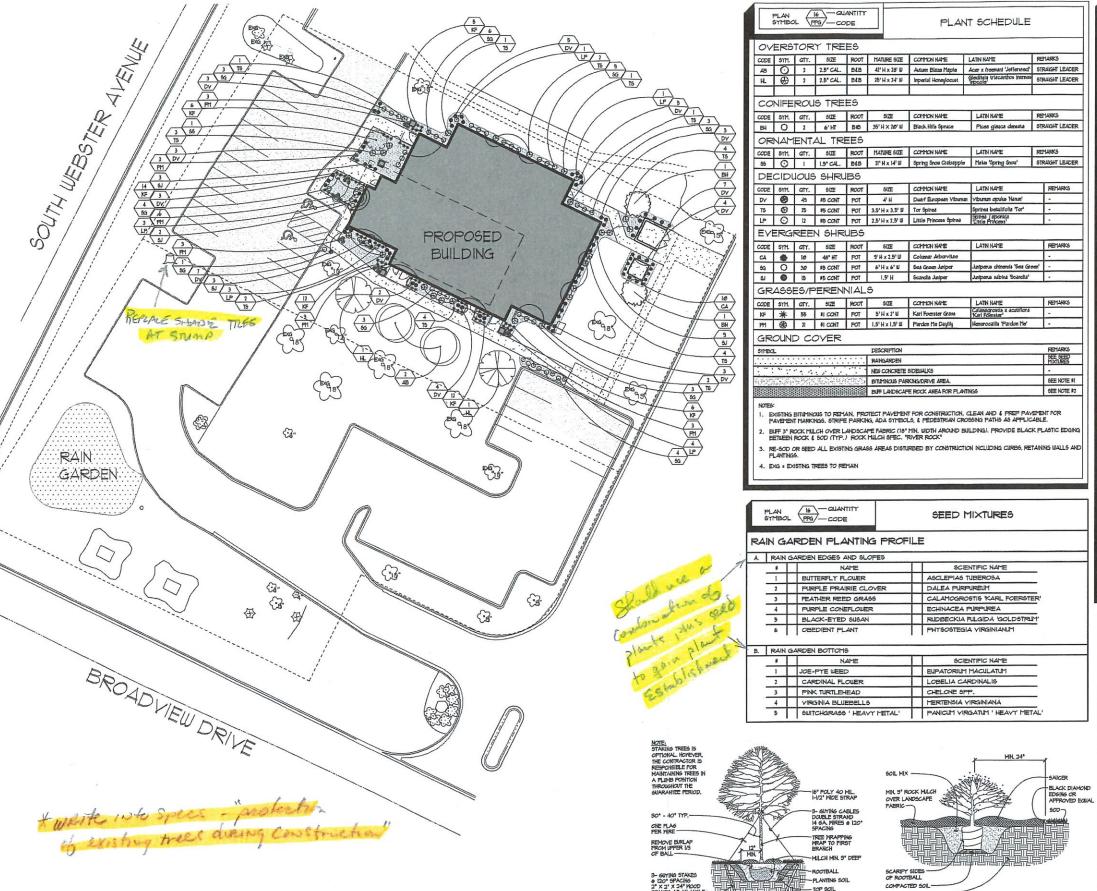

LANDSCAPE PLAN

PREPARE AREA MIN. TREE PLANTING DETAIL

NOT TO SCALE

3 SHRUB PLANTING DETAIL

ANDSCAPE NOTES:

- ALL FLANTING IN TURF AREAS SHALL BE IRRIGATED WITH AN UNDERSPOUND IRRIGATION
 SYSTEM. NO WATER IS ALLOWED ON ANY
 PAVEMENT, PARKING, WALKWAY OR BUILDING. THE
 IRRIGATION CONTRACTOR IS TO DESIGN AND SUBMIT SHOP DRAWING OF IRRIGATION DESIGN AND CALCULATIONS TO ARCHITECT FOR REVIEW PRIOR TO INSTALLATION, IRRIGATION DESIGN IS TO MEET ALL CITY FLUMEING CODES AND REQUI
- EDGE ALL SHRUB AND PERENNIAL BEDS WITH SIX (6) NICH WIDE BY 1/8* THICK BLACK POUDER COATED GALVANIZED STEEL LANDSCAPE EDGING.
- 3. PROVIDE FOUR (4) INCH MINITUM DEPTH OF SHREDDED HARDWOOD BARK MULCH IN FOUR (4) FOOT DIAMETER RING AROUND ALL TREES LOCATED IN TURE AREAS, NO VINYL EDGING IS REQUIRED FOR TREES LOCATED IN SHRUB AREAS
- PROVIDE FOUR (4) INCH MINIMUM DEPTH OF SHREDDED HARDWOOD BARK MULCH IN ALL SHRIB AREAS,
- 5. PROVIDE THREE (3) NCH DEPTH OF SHREDDED HARDWOOD BARK MULCH IN ALL FERENNIAL
- PROVIDE THREE (3) NOH DEPTH OF ONE AND ONE-HALF (1.5) INCH RIVER ROCK OVER BLACK LANDSCAPE FABRIC UNLESS OTHERWISE NOTED ON
- LANDSCAPE CONTRACTOR IS RESPONSIBLE FOR LANDSCAPE CONTRACTOR IS RESPONDIBLE FOR FINISHED GRADING AND POSITIVE SUFFACE DRANAGE IN ALL LANDSCAPE AREAS. LANDSCAPE CONTRACTOR MUST ENSURE THAT THE FINAL GRADES ARE HET AS SHOUN ON GRADING PLAN, IF ANY DISCREPANCIES ARE FOUND, IMPEDIATELY NOTIFY ARCHITECT FOR RESOLUTION.
- ALL PLANT MATERIALS ARE TO CONFORM WITH STATE AND LOCAL CONSTRUCTION STANDARDS AND THE CURRENT ADDITION OF THE AMERICAN AND THE CURRENT ADDITION OF THE REPORT ASSOCIATION OF NURSERTHEN STANDARDS, ALL PLANT MATERIALS ARE TO BE HEALTHY, HARDY STOOK, AND PREE FROM ANY DISEASES, DAMAGE
- CUANTITIES OF PLANTS LISTED ON THE PLAN ARE TO GOVERN ANY DISCREPANCY BETWEEN THE CUANTITIES SHOUN ON THE PLAN SCHEDULE AND PLAN. FLACE PLANTS IN PROFER SPACING
- 0. SOD SHOWN ON LANDSCAPE PLAN TO BE INSTALLED BY LANDSCAPE CONTRACTOR. SOD TO BE LAWN SOD, FREE OF WEEDS AND DISEASE. APPLY MINIMUM SIX (6) INCHES OF TOPSOIL AND THOROUGHLY FERTILIZE BEFORE LAYING SOD. LANDSCAPE CONTRACTOR TO HAINTAIN SODDED ARES IN HEALTHY CONDITION.
- I PLANTING SOIL FOR BACKFILLING TO BE TOPSOIL WITH 3 LBS. OF CONTERCIAL FERTILIZER AND ONE-FITH YARD OF FEAT HUMLS PER CUBIC YARD. TOPSOIL TO BE SELECT TOPSOIL BORROL
- 2. SPREAD PLANTING SOIL AT MINIMUM EIGHTEEN (18) INCH DEEP IN ALL PERENNIAL BEDS PRIOR TO
- FOLLOW LANDSCAPE DETAILS FOR ALL INSTALLATION, UNLESS OTHERWISE NOTED.
- 14. LANDSCAFE CONTRACTOR TO HAINTAIN FLANTS IN HEALTHY CONDITION THROUGHOUT GUARANTY PERIOD. THE GUARANTY PERIOD IS TWO GROWING SEASONS FROM DATE OF PROVISIONAL

LANDSCAPING:

VILLAGE OF ALLOUEZ

ZONING CODE 11.29 (10-8) AT LEAST 20 PERCENT OF THE TOTAL LOT AREA SHALL REMAIN OPEN SPACE

31,562 SF 7,050 SF / 22% 10,752 SF / 34% 13,760 SF / 44% TOTAL PARCEL AREA BUILDING AREA: PAVEMENT AREA: GRASS & LANDSCAPED AREA:

- (+1)
 CNE (I) TREE PER 1,000 SOUARE FEET OF GROSS
 FLOOR AREA, AND ANY FRACTION THEREOF, FOR
 NONRESIDENTIAL USES.
- (8060 ÷1000 = 48) CHE (1) TREE PER EVERY EIGHT (8) PARKING
- (20 + 8 = 42.5) (42.5 FOR PARKING SOUTH OF SITE) ONE (I) STREET TREE FOR STREET FRONTAGES GREATER THAN 100 FEET. (127 LE PRONTAGE : 4)

(TOTAL 15 TREES REQUIRED.

PROVIDEDED LANDSCAPE 5 TREES (43 EXISTING SOUTH OF SITE) ADDITIONAL: 7 TREES

PROJECT NO: 16-064

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SURGE

BAY

GREEN

Q

LANDSCAPE

PLAN

2825 S.WEBSTER AVE ALLOUEZ, WI 54301

999999

PORESTALA C No. DIRE CTOR

Trevor Fuller

From:

Craig Berndt

Sent:

Thursday, February 16, 2017 3:53 PM

To:

SchuhC@ayresassociates.com

Cc:

Trevor Fuller

Subject:

Surgery Center of GB Stormwater

Hi Craig-

This is a follow-up to our telephone conversation of yesterday regarding stormwater requirements for the Surgery Center project.

This project will require a stormwater permit and engineering submittal for the project. The village post-construction stormwater ordinance, for a site of less than 20,000 ft2 disturbed area, requires stormwater treatment the same as a larger site but we do not impose a hard numerical discharge limit to allow some flexibility. Treatment methods are the same as a larger project, so consider the type and extent of treatment needed and include this in your stormwater application.

This project will discharge stormwater to the storm sewer that ultimately discharges to the village Heritage Hill stormwater pond. Treatment at this pond is expected to be removals of 69% TSS and 48% TP. You may elect to purchase treatment capacity at this pond rather than construct full treatment at on the project site. The fee in lieu of treatment cost is \$18 per ton of TSS applied as a one-time charge based on the annual discharge amount. We would have to determine the TP treatment cost.

The Fox River TMDL treatment requirements are removals of 72% TSS and TP of 42% removal. Your discharge, from the project site plus the pond (if you purchase capacity) must meet this requirement. If you do not purchase treatment capacity then the site discharge must meet this requirement. The amount of treatment you need to provide is not very much, but we do still require the flow equalization criteria.

Please let me know when you plan to submit the application and stormwater information. We will proceed with the planning commission approval process, but the building permit will not be issued until the stormwater permit has been issued. On complex projects it requires some time to review the stormwater permit application and engineering report, but this project is simpler so this should be a short review.

Please let me know if you have questions. Thanks, Craig

Craig L. Berndt, P.E.
Director, Public Works
Village of Allouez
1900 Libal Street
Green Bay, WI 54301
(920) 448-2800
Craig@villageofallouez.com