Agenda Item Number	14	4d	
Agenda item Number	_	IU	

Memo

To: Village Board

Fr: Trevor Fuller, Planning and Zoning Administrator

Re: ACTION RE: PETITION FROM SURGERY CENTER OF GREEN BAY – SITE PLAN AND DESIGN REVIEW ON

PARCEL AL-2127, LOCATED AT 2825 S WEBSTER AVENUE

Date: 03 March 2017

Attached are the proposed plans submitted by the EV Acquisitions, LLC. for the site plan and design review of the proposed development of the Surgery Center of Green Bay at 2825 S. Webster Avenue (see attachments 1A, 1B). A representative from Ayres Associates will be present at the meeting to talk about the project and answer any questions.

Site Plan and Design Review Process

The site plan and design review process is an opportunity for the Village Board and the plan commission members to review and to ensure the plans meet village standards in regards to safety, efficiency, aesthetics, and legal concerns in a public forum. The village cannot consider the use of the parcel as part of the decision in this process, only review if the proposed development meets all site plan and design standards for this zoning district.

The proposed project is for parcels AL-2127, located at 2825 S. Webster Avenue. This parcel is zoned "C" Professional Office and Residence District" and the proposed use is allowed under this zoning classification. The village is asked to review the Surgery center of Green Bay development proposal and determine if the proposed project meets the zoning and design requirements required by the zoning code for this proposed use.

Staff Comments and Recommendation

Staff has reviewed the proposed plans and has provided the representatives from EV Acquisitions, LLC. with comments (see attachments 2A, 2B, 2C, 2D).

The Plan Commission reviewed at the February 27th meeting and recommended approval by the Village Board contingent on a parking and cross traffic easement agreement being produced between the two parcels (see attachment 3A), the exterior siding material chosen is compliant with applicable zoning requirements, staff comments be addressed, and a pedestrian access to Webster Avenue is provided.

Staff recommends approval by the petition by the Village Board, should all comments be addressed and necessary permits be filed prior to a final building permit being issued or a reasonable explanation (as determined by staff and the Village Board) as to why these comments were not addressed.

Village Board is asked to review and determine whether or not to approve the petition from EV Acquisitions, LLC., requesting a site plan and design review for a development on parcel AL-2127, located at 2825 S. Webster Avenue.

SPR#	ΙΛ
Date:	_
Receipt#	

DEVELOPER CHECKLIST FOR COMPLETION OF SITE PLAN REVIEW SUBMITTAL

(\$125 required application fee)

Name	of project: Surgery Center of Green Ba	ay	
Addres	s of project: 2825 S Webster Avenue		
Name	of developer:	Name of	fowner:_EV Acquisitions, LLC
request	e considered for the site plan review process, this content of the content of the erosing time of the erosing time of the erosing of the eros		
	plans and subsequent revisions must be date inch equals one hundred (100) feet. Complet		
X	 One (1) full size plan set. Fifteen (15) eleven (11) inches by seventeen (17) inches plan sets. 	X	3. One (1) digital copy (either a CD or DVD) containing AutoCAD.dwg files referenced to the Brown County Coordinate System NAD83, NAV88.
All plar	sets shall include the following information:		
X	Name and street address of project/development.		communication poles and transmission lines
X	2. Name and mailing address of developer/owner.		 All buildings and structures Parking facilities (with provisions for bicycles, scooters, and motorcycles)
X	3. Name and mailing address of engineer/architect.		 Water bodies and wetlands (including flood plain and floodway delineations)
X	4. North point indicator.5. Scale.		Surface water holding ponds, drainage ditches, and drainage patterns
X	6. Boundary lines of property, with		Sidewalks, walkways, trails, and driveways
X	dimensions.7. Location, identification, and dimensions of existing and proposed:		Off street loading areas and docks Fences and retaining walls
	Topographic contours at a minimum interval of two (2) feet		All exterior signsExterior refuse storage/collection areas
	Adjacent streets and street rights-of-way		Exterior lighting
	On site streets and street rights-of-way		Traffic flow on and off site
	Utilities and utility easements for electric; natural gas; telephone; water; sewer (sanitary and storm); fiber optic lines; and antenna, satellite dishes, and other	X	8. Location of open space.9. Site statistics, including site square footage, percent site coverage, percent open space, and floor area ratio.

X	Location and dimensions of proposed door display areas. Architectural rendering of the proposed		15. Other information, not mentioned in Village Ordinance 11.29, considered pertine by Village of Allouez staff and/or the developers shall include, but is not limited t		
▼ 1	structures and buildings, including all exterior dimensions, gross square footage of existing and proposed buildings and structures, and the description of all exterior finish materials.		— within 20	tion of adjacent properties 0 feet of all boundaries and of structures on those es.	
<u>X</u>	12. Erosion control plans.13. A staging plan for any projects involving more than one phase or construction season,		The same of the sa	identification, and ns of existing and proposed lans.	
	including the timeline of construction, the proposed uses and structures of various service facilities, and the estimated completion dates.			identification, and ns of existing and proposeding.	
X	14. Impact analysis to effects of a proposed development on activities, utilities, circulation, surrounding land uses, community		dimension	identification, and ns of existing and proposed tric lighting plans.	
	facilities, noise, environment, and other factors.		Storm wa	iter management plans.	

Contact Information:

Administrator, Brad Lange Allouez Village Hall 1900 Libal Street Green Bay, WI 54301-2453

Phone: (920)448-2800 Fax: (920)4482850

Email: <u>brad@villageofallouez.com</u>

Forms for Site Plan Review and the Village ordinances may be found at the Village website: http://www.villageofallouez.com/

PROJECT NARRATIVE

Surgery Center of Green Bay **Ambulatory Surgery Center**

Village of Allouez, Wisconsin

Project Team:

Owner

EV Acquisitions, LLC C/O Titletown Law 222 Cherry Street Green Bay, WI 54301

Contact:

Cynthia Caine Trevelen

Phone:

920-435-9393

Email:

CTrevelen@titletownlaw.com

Civil Engineer

Ayres Associates 3376 Packerland Drive Ashwaubenon, WI 54115 Contact:

Craig Schuh, PE

Phone:

920-498-0970

Email:

SchuhC@AyresAssociates.com

Architecture

Sperides Reiners Architects, Inc. 4200 West Old Shakopee Road

Suite 220

Bloomington, MN 55437

Contact:

Nick Sperides

Phone:

952-996-9662

Email:

nick@sra-mn.com

Landscape Architecture

Sperides Reiners Architects, Inc.

Project Site Data:

The site is southeast of the intersection of Wisconsin Highway 172 and Webster Ave South. It is east of the Fox River. The site is 0.72-acres (31,562 SF) accessible from a private drive to the east of the site. Highway 172 is the nearest major connector to the north while downtown Allouez is the major node north of the site. The proposed building is in the center of the site with parking on the west and southeast parts of the site

Use:

The proposed building is an ambulatory surgical center (ASC) serves the Green Bay area with operating rooms and associated staff and patient areas. The ASC will house its operational areas on grade level in approximately 6,750 square feet. Its mechanical space will be placed in its attic space in approximately 1,300 square feet.

The design team is working to resolve a complete exterior material pallete with the owner. All materials will be compliant with Allouez Zoning Code 11.29 (9a). Contact architect for previous design study.

Light and light pollution

Parking lot standards will host full cut-off fixtures with less than .5 foot candles reaching the property line in any direction. Building mounted lighting includes full cut-off housings to eliminating glare and unwanted light wash. Architecturally integrated lights are added at the accessible entrances to provide path lighting.

Impact analysis

The ASC will benefit the community and provide a professional environment to care for health in the Green Bay area. Area activities will not be impacted. Its impact to utilities is depicted on the civil engineer's plans. Additionally, circulation is not impacted as the building sits within a buildable site; the street and parking circulation remain intact.

Impact to the surrounding land uses is positive. Surrounding uses include a correctional facility, an aquatic center, and orthodontic practices. These uses likely would benefit from having a state of the art surgical practice in their proximity.

Impact to the environment, noise, and community would also be positive. The ASC structure fills in a gap within the surrounding built-up neighborhood. The ASC weaves into the neighboring community with a hipped roof, high quality construction materials, and integrated mechanical space.

Sustainable Initiatives Summary

Sustainable initiatives are a priority in responsible design practiced and implemented by Sperides Reiners Architects. The ASC will have a variety of daylighting strategies, including building footprint dimensions that allow for the use of exterior windows directly into occupied waiting spaces. Additionally, the building will also integrate efficient systems and envelope designs to maximize its operational efficiencies and economics.



EV Acquisitions LLC C/O Titletown Law 222 Cherry Street Green Bay, WI 54301

Surgery Center of Green Bay Ambulatory Surgery Center Village of Allouez, Wisconsin

Stormwater Management Plan

The Surgery Center of Green Bay is proposing to build a new facility containing approximately 7,000 square feet of level floor space. Additionally, sidewalk and landscaping will be installed around the proposed building along with a generator and dumpster pad. No other site improvements are expected to take place with the exception of a bioretention area which will be constructed in the southwest corner of the site.

Per the Village of Allouez codes and ordinances, this site is exempt from meeting the total suspended solids (TSS) and total phosphorus (TP) reduction requirements for the Fox River TMDL along with peak discharge requirements. The proposed site does not have more than 20,000 square feet of impervious surface disturbance or more than one acre of total land disturbance. Although the site is not required to meet the listed reduction levels, the bioretention area serves as an appropriate best management practice (BMP) in order to reduce TSS and TP loading as well as peak discharges.

The bioretention area shall be maintained and warranted by the Contractor for a duration of two years after installation. Maintenance activities include; but are not limited to: erosion control repair, weed control, trash removal, plant replacements as necessary, biomass cutting and removal at the end of the season. Following the two-year warranty period, the property owners will accept all maintenance responsibilities.










SURGERY CENTER OF GREEN BAY

2825 S WEBSTER AVE ALLOUEZ, WI 54301

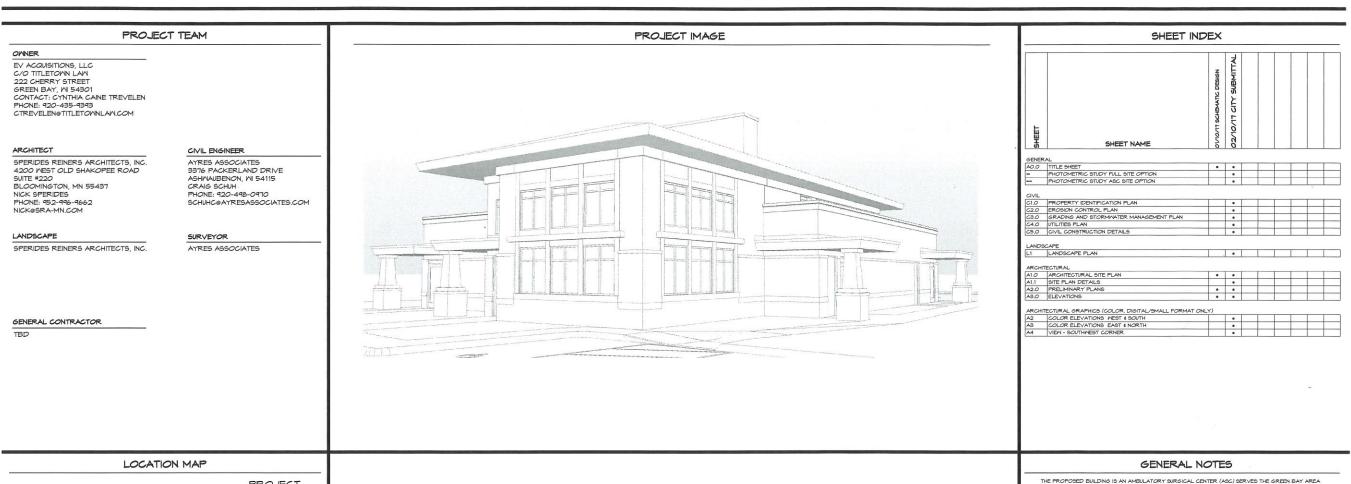

LOCATION MAP PROJECT LOCATION Woodlowin Cemetery Allouez Village of O Allouez Village of O De Pere George St De Pere George St

THE PROPOSED BUILDING IS AN AMBULATORY SURGICAL CENTER (ASC) SERVES THE GREEN BAY AREA WITH OPERATING ROOMS AND ASSOCIATED STAFF AND PATISHT AREAS, THE ASC MILL HOUSE ITS OPERATIONAL AREAS ON GRADE LEVEL IN APPROXIMATELY 6, TSO SQUARE FEET. ITS MECHANICAL SPACE WILL BE PLACED IN 1TS ATTIC SPACE IN APPROXIMATELY 1, ISOO SQUARE FEET.

SPERIDES REINERS ARCHITECTS, INC.

4800 WEST OLD SHAKOPEE ROA SUITE 280 PH: 952-996-9668 PX: 952-996-9663 WWW.SRA-MN.COM

Printer of

| ISSUE RECORD | ISSUE RECORD | ISSUE # | DATE | DESCRIPTION | DESCRIPTION | O11.00077 | CITY-SUBMITHAL | O21.00077 | O21.00077 | O2

SURGERY CENTER OF GREEN BAY

TITLE SHEET

PROJECT NO: 16-DRAWN BY: E.M

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ISSUE:

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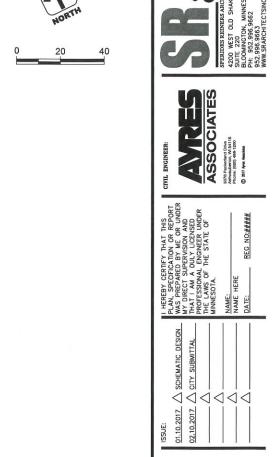
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N X X SURGERY CEN OF GREEN BA 2825 S.WEBSTER AVENUE ALLOUEZ, WI 54301

• PROPERTY IDENTIFICATION PLAN

PROJECT NO: 16-064 DRAWN BY: A.E. CHECKED BY: C.S.







SURGERY CENTER OF GREEN BAY 2825 S.WEBSTER AVENUE ALLOUEZ, WI 54301

PROJECT NO: 16-064 DRAWN BY: A.E. CHECKED BY: C.S.

• EROSION CONTROL PLAN

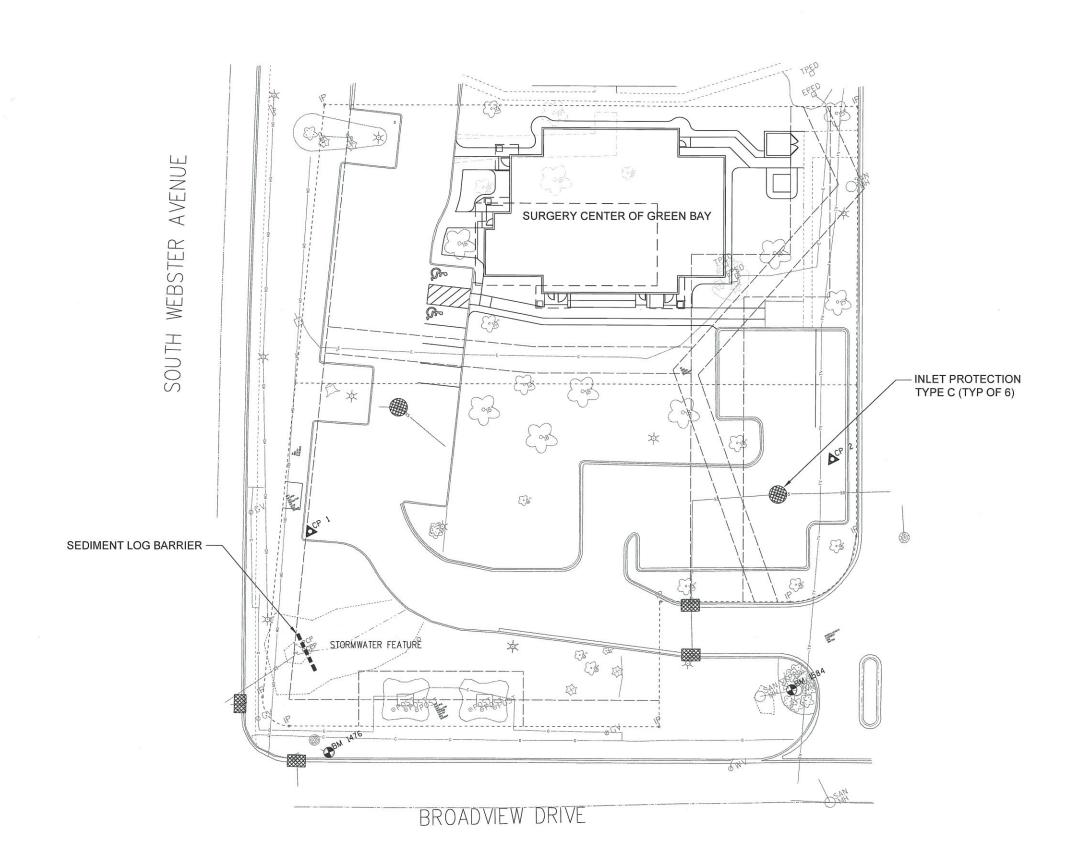

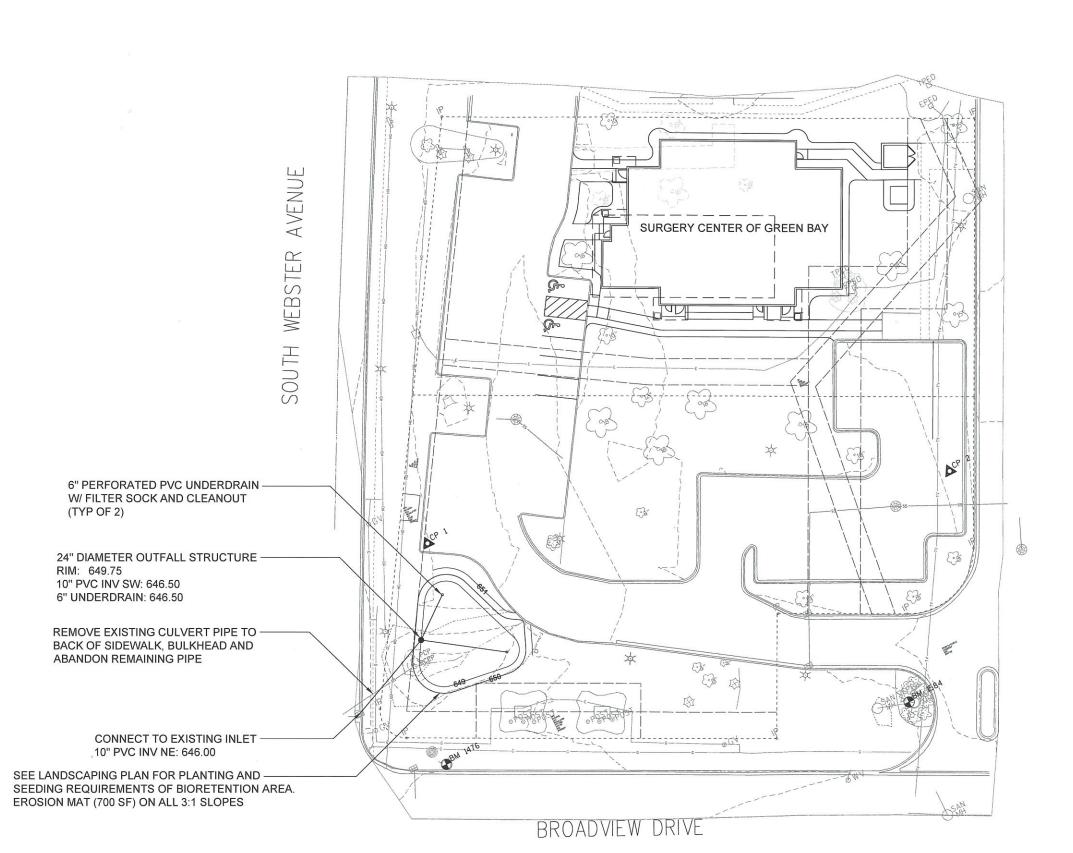






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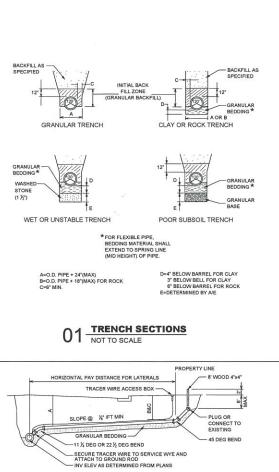
• GRADING STORMWATER MANAGEMENT PLAN


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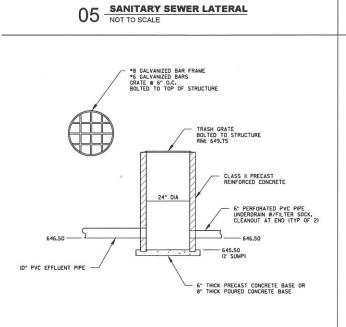


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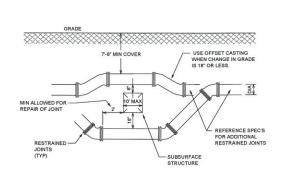
• UTILITIES

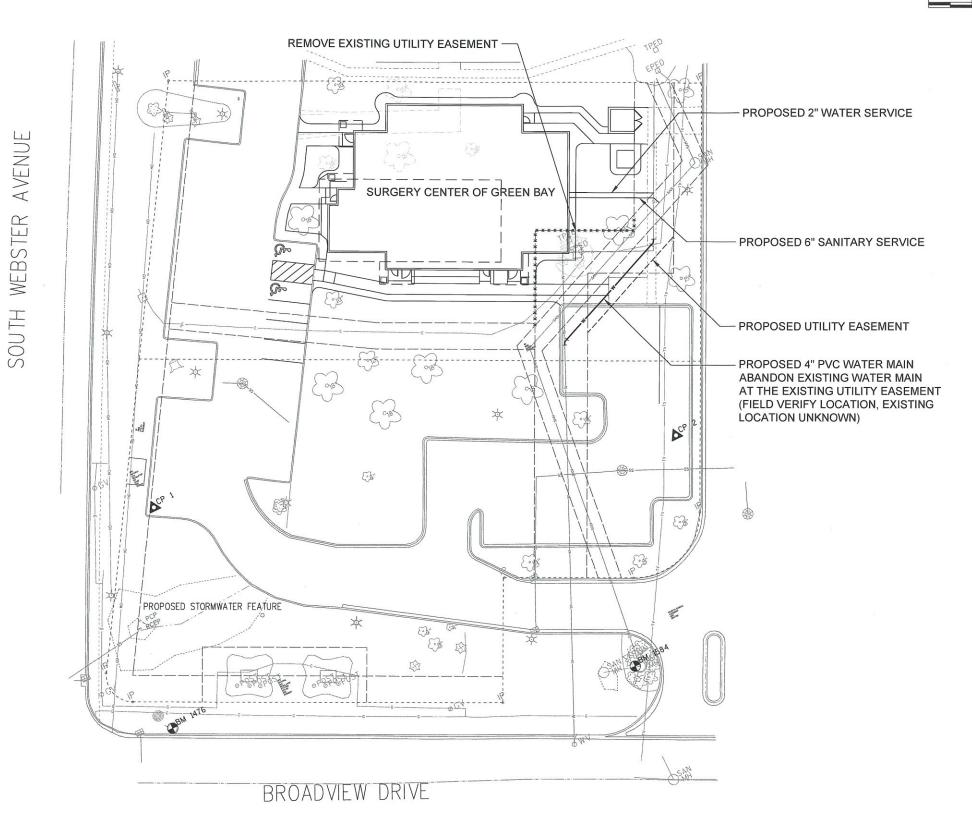




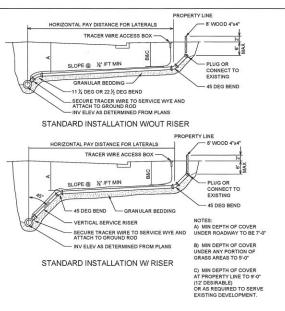


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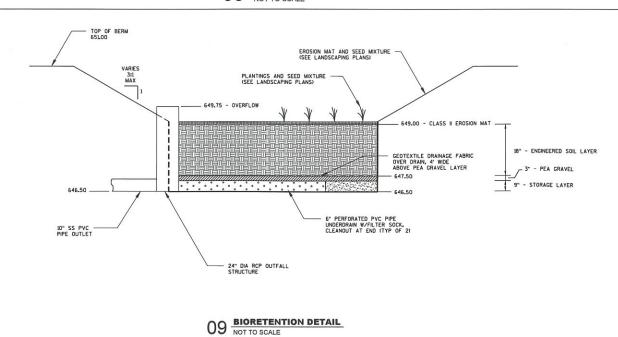
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03 STANDARD VALVE BOX SETTING NOT TO SCALE




06 INLET PROTECTION NOT TO SCALE

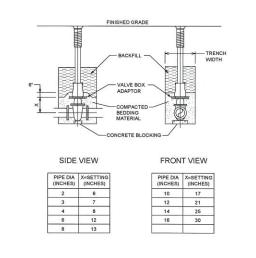

- TAP WATER MAIN ON 45° WITH PIPE. MINIMUM HORIZONTAL DISTANCE BETWEEN CORP STOPS SHALL BE 3-FEET.

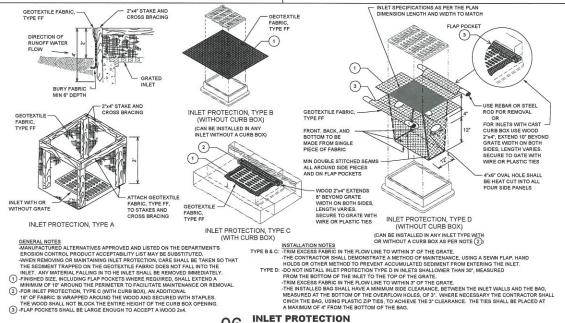$04 \; \tfrac{\text{WATER SERVICE INSTALLATION}}{\text{NOT TO SCALE}}$

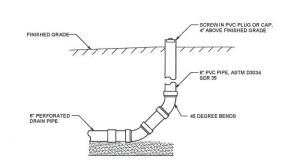

 $07 \, \frac{\text{CLEANOUT}}{\text{NOT TO SCALE}}$

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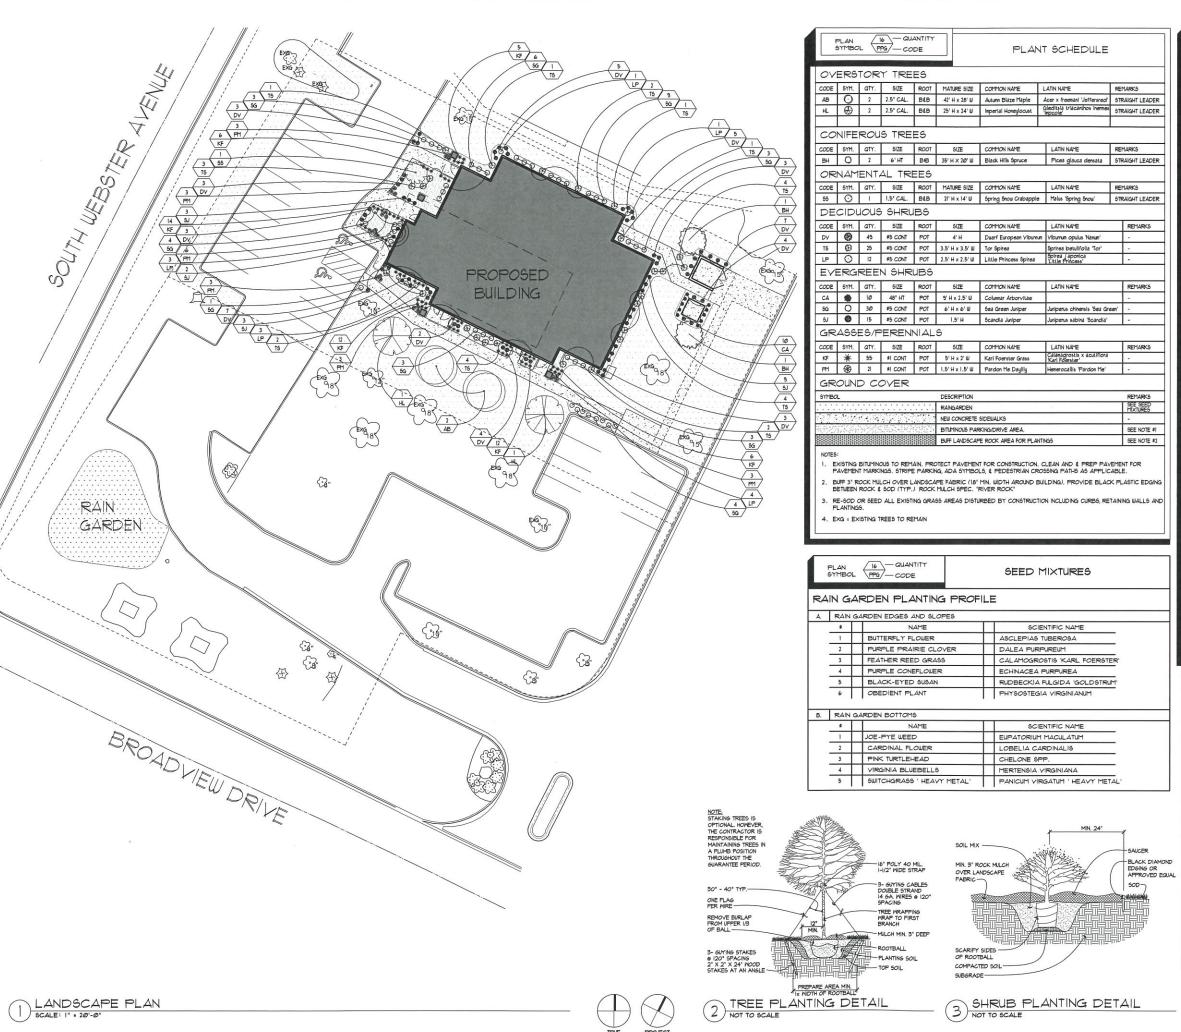
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I HEREBY CERTIFY THAT TH PLAN, SPECIFOTATION OR RI WAS PREPARED BY WE OF WAY DIRECT SUBFENSION AN THAT I AM A DULY LICENSE PROFESSIONAL ENGINEER US MINNESOTA.

• CIVIL CONSTRUCTION DETAILS

PROJECT NO: 16-064 DRAWN BY: A.E. CHECKED BY: C.S.



LANDSCAPE NOTES

ALL PLANTING IN THEE APEAS SHALL BE IRRIGATED WITH AN UNDERGROUND IRRIGATION SYSTEM, NO WATER IS ALLOWED ON ANY PAVEMENT, PARKING, WALKWAY OR BUILDING, THE IRRIGATION CONTRACTOR IS TO DESIGN AND SUBMIT SHOP DRAWING OF IRRIGATION DESIGN AND CALCULATIONS TO ARCHITECT FOR REVIEW PRIOR TO INSTALLATION. IRRIGATION DESIGN IS TO MEET ALL CITY PLUMBING CODES AND REQUIREMENTS.

2. EDGE ALL SHRUB AND PERENNIAL BEDS WITH SIX (6) INCH WIDE BY 1/8" THICK BLACK POWDER
COATED GALVANIZED STEEL LANDSCAPE EDGING.

3 PROVIDE FOUR (4) INCH MINIMUM DEPTH OF SHREDDED HARDWOOD BARK MULCH IN FOUR (4) FOOT DIAMETER RING AROUND ALL TREES LOCATED IN TURF AREAS. NO VINYL EDGING IS REQUIRED FOR TREES LOCATED IN SHRUB AREAS AND SEEDING AREAS.

. PROVIDE FOUR (4) INCH MINIMUM DEPTH OF SHREDDED HARDWOOD BARK MULCH IN ALL SHRUB AREAS.

5. PROVIDE THREE (3) INCH DEPTH OF SHREDDED HARDWOOD BARK MULCH IN ALL PERENNIAL

6.PROVIDE THREE (3) INCH DEPTH OF ONE AND ONE-HALF (L.S.) INCH RIVER ROCK OVER BLACK LANDSCAPE FABRIC UNLESS OTHERWISE NOTED ON

7. LANDSCAPE CONTRACTOR IS RESPONSIBLE FOR FINISHED GRADING AND POSITIVE SURFACE DRAINAGE IN ALL LANDSCAPE AREAS.

LANDSCAPE CONTRACTOR MUST ENSURE THAT THE FINAL GRADES ARE MET AS SHOWN ON GRADING PLAN. IF ANY DISCREPANCIES ARE FOUND. MMEDIATELY NOTIFY ARCHITECT FOR RESOLUTION.

8. ALL PLANT MATERIALS ARE TO CONFORM WITH STATE AND LOCAL CONSTRUCTION STANDARDS AND THE CURRENT ADDITION OF THE AMERICAN ASSOCIATION OF NURSERYMEN STANDARDS. ALL PLANT MATERIALS ARE TO BE HEALTHY, HARDY STOCK, AND FREE FROM ANY DISEASES, DAMAGE AND DISFIGURATION.

9. QUANTITIES OF PLANTS LISTED ON THE PLAN ARE TO GOVERN ANY DISCREPANCY BETWEEN THE QUANTITIES SHOWN ON THE PLAN SCHEDULE AND PLAN. PLACE PLANTS IN PROPER SPACING FOLLOWING LAYOUT FIGURES.

IØ. SOD SHOWN ON LANDSCAPE PLAN TO BE INSTALLED BY LANDSCAPE CONTRACTOR, SOD TO BE LAWN SOD, FREE OF WEEDS AND DISEASE. APPLY MINIMUM SIX (6) INCHES OF TOPSOIL AND THOROUGHLY FERTILIZE BEFORE LAYING SOD. LANDSCAPE CONTRACTOR TO MAINTAIN SODDED ARES IN HEALTHY CONDITION.

I. PLANTING SOIL FOR BACKFILLING TO BE TOPSOIL WITH 3 LBS. OF COMMERCIAL FERTILIZER AND ONE-FIFTH YARD OF PEAT HUMMUS PER CUBIC YARD, TOPSOIL TO BE SELECT TOPSOIL BORROW

2. SPREAD PLANTING SOIL AT MINIMUM EIGHTEEN (18) INCH DEEP IN ALL PERENNIAL BEDS PRIOR TO

13. FOLLOW LANDSCAPE DETAILS FOR ALL INSTALLATION, UNLESS OTHERWISE NOTED

4 LANDSCAPE CONTRACTOR TO MAINTAIN PLANTS IN HEALTHY CONDITION THROUGHOUT GUARANTY
PERIOD. THE GUARANTY PERIOD IS TWO GROWING SEASONS FROM DATE OF PROVISIONAL ACCEPTANCE UNTIL FINAL ACCEPTANCE

LANDSCAPING:

VILLAGE OF ALLOUEZ ZONING CODE 11.29 (10-8) AT LEAST 20 PERCENT OF THE TOTAL LOT AREA SHALL REMAIN OPEN SPACE

31,562 SF 7,050 SF / 22% 10,752 SF / 34% 13,760 SF / 44% BUILDING AREA: PAVEMENT AREA: GRASS & LANDSCAPED AREA:

REQUIRED LANDSCAPE ONE (1) TREE PER DWELLING UNIT.

ONE (1) TREE PER 1,000 SQUARE FEET OF GROSS FLOOR AREA, AND ANY FRACTION THEREOF, FOR NONRESIDENTIAL USES. (8,060 + 1,000 = +8)

ONE (1) TREE PER EVERY EIGHT (8) PARKING STALLS.

(20 + 8 = 42.5) (+2.5 FOR PARKING SOUTH OF SITE) ONE (1) STREET TREE FOR STREET FRONTAGES GREATER THAN 100 FEET.

(127 | F FRONTAGE = +1) (TOTAL 15 TREES REQUIRED)

PROVIDEDED LANDSCAPE

EXISTING: 5 TREES (+13 EXISTING SOUTH OF SITE) ADDITIONAL: 7 TREES

PROJECT NO: 16-064 DRAWN BY: E.M. CHECKED BY: N.S.

PRELIMINARY NOT FOR CONSTRUCTION


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LANDSCAPE

PLAN



GENERAL SITE PLAN NOTES:

- BEARING, DIPENSIONS, AND EASEMENTS SHOWN HEREON ARE FOR REFERENCE ONLY. REFER TO PROJECT ALTA/ASCH LAND TITLE SURVEY FOR PROPERTY LEGAL DESCRIPTION AND VERIFICATION OF REFERENCED INFORMATION
- G.C. TO COORDINATE ALL DIMENSIONS WITH SURVEY AND CIVIL DRAWINGS. NOTIFY ARCHITECT / ENGINEER OF ANY DISCREPANCIES
- ALL AREAS NOT OTHERWISE NOTED SHALL BE LANDSCAPED. REFER TO THE LANDSCAPE PLAN FOR ADDITIONAL INFORMATION SHALL BE LANDSCAPED. COORDINATE THE PHASES OF CONSTRUCTION AND PLANTING INSTALLATIONS WITH OTHER CONTRACTORS WORKING ON SITE
- EXISTING TREES SHALL BE PROTECTED AND SAVED UNLESS NOTED TO BE REMOVED. ANDIOR ARE IN AN AREA TO BE GRADED. PROTECT TREES WITH FROME WHERE CAPABLE PLACE AT THE DRIP LINE OF THE TREE. HANTAIN CLEARANCE FOR CITY STREET SHOW RETOVAL, ANY CLESTION REGARDING WEFTER PLAIM TATENUT, SHOULD REMAIN OR NOT SHALL BE BROUGHT TO THE ATTENTION OF THE ARCHITECT PRIOR TO REMOVAL.
- THE CONTRACTOR SHALL CONTACT ALL PUBLIC UTILITIES FOR LOCATIONS OF ALL NIDERGROUND WIRES, CABLES, CONDUITS, PIFES, MANNOLES, VALVES, OR OTHER BURIED STRUCTURES BEFORE DIGGAINS, CONTACT DIGGERS HOTINE, 16690/1249-8811. CONTRACTOR SHALL REPAIR OR REFLACE THE ABOVE WHEN DAMAGED, ALL RODAULAT PAVETHENT, SIDEWALK, AND CURBS & GUITTER REPROVED DURNES WITTY INSTALLATION SHALL BE REPLACED WITH EQUIVALENT SECTIONS AS REQUIRED, ANY WORK DONE TO SIDEWALKS AND CURBS & WITHIN THE PUBLIC RIGHT OF WAY MUST BE DONE TO CITY STANDARDS AND SPECIFICATIONS
- ANY DAMAGE TO ADJACENT SIDEWALKS, CURBS, OR PAVEMENT MUST BE REPAIRED TO MATCH MATERIALS OF CURRENT CONDITION
- ALL EXISTING CONDITIONS SHALL BE REMOVED AS REQUIRED TO ACCOMMODATE PROPOSED CONSTRUCTION, WHETHER OR NOT NOTED ON DEMOLITION PLAN.
- PROVIDE A SAFE PASSAGE THROUGH AND/OR AROUND CONSTRUCTION SITE AS REQUIRED, COORDINATE WITH EXISTING NEIGHBORING PROPERTY MANAGERS AND VILLAGE STAFF AS REQUIRED

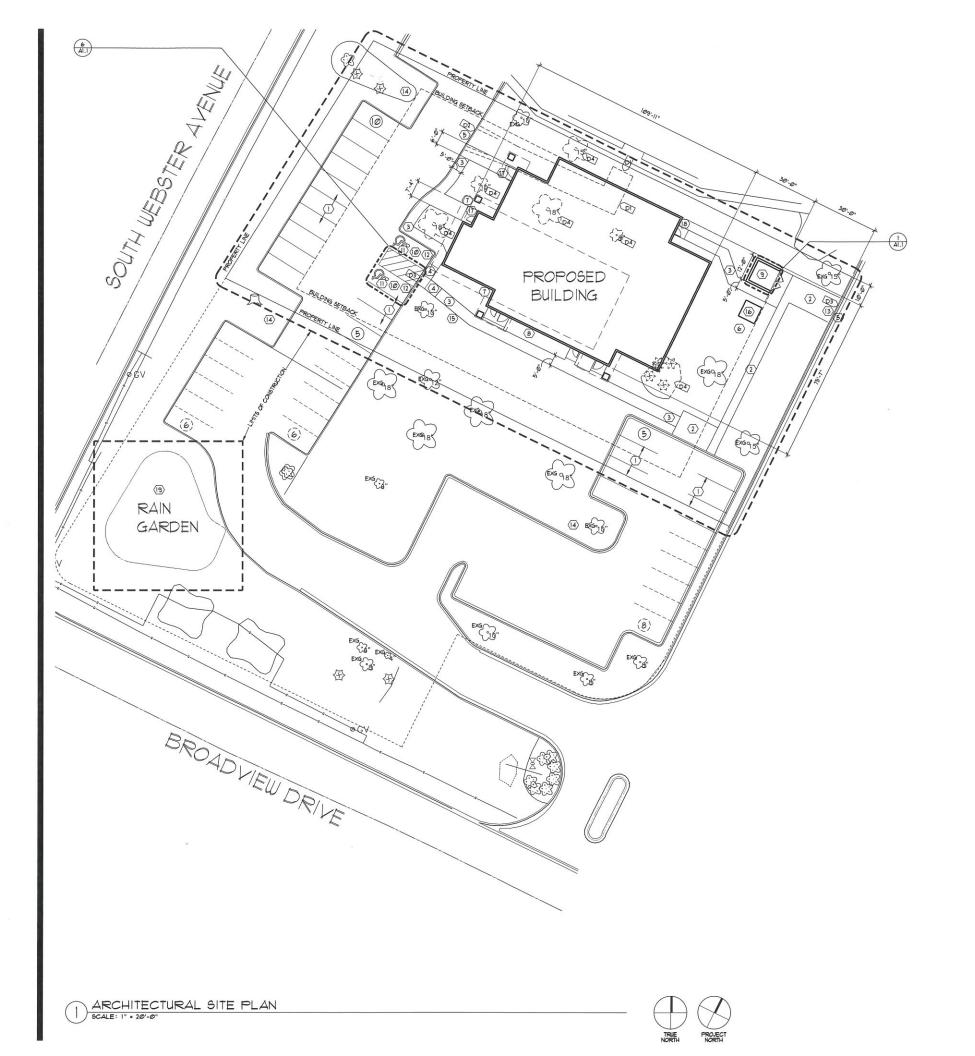DEMOLITION KEYED NOTES:

- DI SAWCUT SIDEWALK AND REMOVE.
- D2 REMOVE CURB AND GUTTER:
- PEMOVE CURB AT NEAREST JOINT, PREPARE EXISTING CURB FOR SLOPED CONCRETE FLATWORK.
- D4 EXISTING TREES TO BE REMOVED

SITE PLAN KEYED NOTES:

- (I) EXISTING ASPHALT PAVING, TO REMAIN. RESTRIPE PAVMENT AS REQUIRED.
- 2 EXISTING CONCRETE WALK, TO REMAIN.
- (3) CONCRETE SIDEWALK, SLOPE AWAY FROM THE BUILDING. SLOPE TO BE GREATER THAN 1:100 AND NO STEEPER THAN 1:48.
- (4) ACCESSIBLE RAMP W/ DETECTABLE WARNING ALONG ACCESSIBLE ROUTES (TYP.). SLOPE TO BE GREATER THAN 1:20 AND NO STEEPER THAN 1:12.
- (5) CONCRETE CURB. SEE CIVIL FOR LOCATIONS & DETAILS.
- (6) PAD MOUNTED TRANSFORMER WITH BOLLARDS, (COORDINATE W/ P.A., ANY OTHER LOCATIONS).
- 7) PROJECTED BUILDING OVERHANG, ABOVE (SHOWN DASHED).
- (8) GAS METER. COORDINATE WITH MECHANICAL.
- 9 REFUSE AND RECYCLING ENCLOSURE.
- ACCESSIBLE PARKING SPACES AND THEIR ACCESS AISLES SHALL BE I 1/2% (2% MAX.) SLOPE IN ALL DIRECTIONS.
- (I) PAINTED ACCESSIBLE PARKING SYMBOL TO MEET ALL GOVERNING CODES.
- (12) ACCESSIBLE PARKING SIGN AT ALL ACCESSIBLE STALLS.
- (13) CONFIRM SLOPE AT PAVEMENT WITH TRASH COMPANY.
- (15) BIKE RACK, DERO ROLLING RACK RR2H OR EQUAL. COLOR: TBD.
- (6) EMERGENCY GENERATOR, COORDINATE WITH ELECTRICIAN AND MEDICAL EQUIPMENT SUPPLIER.
- (17) AUTOMATIC DOOR OPERATOR SWITCH ON SQUARE BOLLARD FOST, MINIMIM 5'V5".
 BOLLARD TO BE SWEACE-MOUNTED TO OUTSIDE EDGE OF CONCRETE STOOP, BOLLARD
 TO BE FINSHED TO MATCH BUILDING EXTERIOR MATERIAL. SEE BYLARGED FLOOR FLAN
 AND DOOR MARDWARE.
- (18) PRELIMINARY MEDGAS LOCATION. COORDINATE WITH MEDICAL EQUIPMENT SUPPLIER.
- (19) RAINGARDEN. SEE CIVIL DRAWINGS FOR GRADING AND UTILITIES.

PARKING REQUIREMENTS

PROPOSED BUILDING FOOTPRINT AREA = 6,760 SQ. FT. BUILDING AREA W MEZZANINE = 8,060 SQ. FT. PARKING REQUIRED = 1 PER 200 SQ. FT. = 40 STALLS PARKING PROVIDED = 40 STALLS 20 STALLS ON SITE & 20 STALLS IN VICINITY CONFORMS TO VILLAGE OF ALLOUEZ ZONING 11.13 (K)

SHALL RECEIVE ONE SPACE FOR EACH 200 SF OF FLOOR AREA

ADA PARKING SPACES: & VAN ACCESSIBLE = 2 SPACES PROVIDED


PRELIMINARY NOT FOR CONSTRUCTION

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OF GREEN BAY
2825 S.WEBSTER AVENUE
ALLOUEZ, WI 54301 Ш

 ARCHITECTURAL SITE PLAN

PROJECT NO: 16-064 DRAWN BY: E.M. CHECKED BY: N.S.

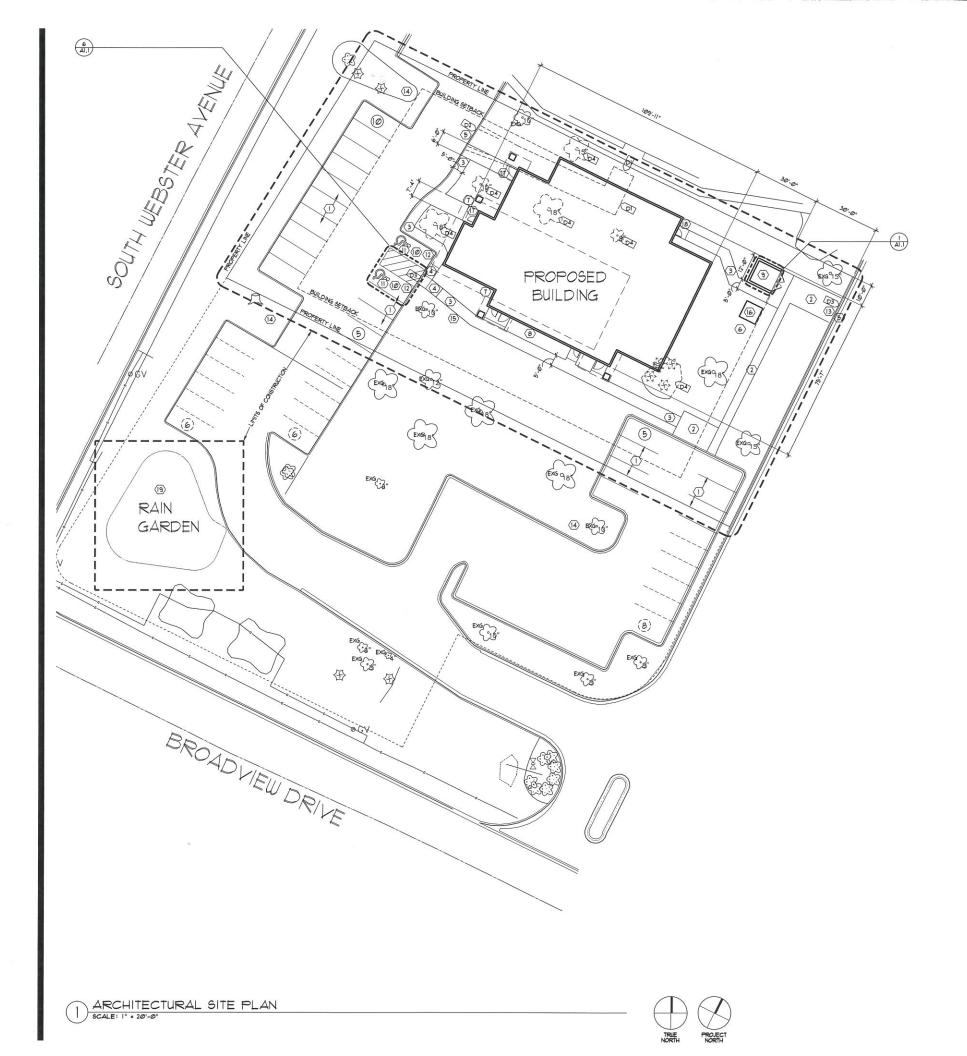

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- ALL AREAS NOT OTHERWISE NOTED SHALL BE LANDSCAPED. REFER TO THE LANDSCAPE PLAN FOR ADDITIONAL INFORMATION SHALL BE LANDSCAPED. COORDINATE THE PHASES OF CONSTRUCTION AND PLANTING INSTALLATIONS WITH OTHER CONTRACTORS WORKING ON SITE
- EXISTING TREES SHALL BE PROTECTED AND SAVED UNLESS NOTED TO BE REMOVED AND/OR ARE IN AN AREA TO BE GRADED. PROTECT TREES WITH FENCING WHERE CAPABLE PLACE AT THE ORIPL INC OF THE TREE. HANTAIN CLEARANCE ORN CITY STREET SHOW REMOVAL, ANY QUESTION REGARDINGS WHETHER PLANT TATERIAL SHOULD REMAIN OR NOT SHALL BE BROUGHT TO THE ATTENTION OF THE ARCHITECT PROTECT TO REMOVED.
- THE CONTRACTOR SHALL CONTACT ALL PUBLIC UTILITIES FOR LOCATIONS OF ALL UNDERGROUND URES, CABLES, CONDUITS, IPIES, MANDIES, VALVES, OR OTHER BURIED STRUCTURES BEFORE DIGGINS, CONTACT DIGGRES HOTHER, 1880;124-9811. CONTRACTOR SHALL REPARK OR REFLACE THE ABOVE UND NOTWISCE ALL ROADMUNT PAVEMENT, SIDEMALK, AND CURBS & GUITTER REPROVED DURING UTILITY INSTALLATION SHALL BE REPLACED WITH EQUIVALENT SECTIONS AS REQUIRED. ANY WORK DONE TO SIDEMALKS AND CURBS WITHIN THE PUBLIC RIGHT OF WAY PLOT BE DONE TO CITY STANDARDS AND SPECIFICATIONS
- ANY DAMAGE TO ADJACENT SIDEWALKS, CURBS, OR PAVEMENT MUST BE REPAIRED TO MATCH MATERIALS OF CURRENT CONDITION
- ALL EXISTING CONDITIONS SHALL BE REMOVED AS REQUIRED TO ACCOMMODATE PROPOSED CONSTRUCTION, WHETHER OR NOT NOTED ON DEMOLITION PLAN.
- PROVIDE A SAFE PASSAGE THROUGH AND/OR AROUND CONSTRUCTION SITE AS REQUIRED. COORDINATE WITH EXISTING NEIGHBORING PROPERTY MANAGERS AND VILLAGE STAFF AS REQUIRED

DEMOLITION KEYED NOTES

- DI SAWCUT SIDEWALK AND REMOVE.
- D2 REMOVE CURB AND GUTTER.
- PEMOVE CURB AT NEAREST JOINT, PREPARE EXISTING CURB FOR SLOPED CONCRETE FLATWORK.
- D4 EXISTING TREES TO BE REMOVED

SITE PLAN KEYED NOTES

- (I) EXISTING ASPHALT PAVING, TO REMAIN. RESTRIPE PAVMENT AS REQUIRED.
- 2 EXISTING CONCRETE WALK, TO REMAIN.
- (3) CONCRETE SIDEWALK, SLOPE AWAY FROM THE BUILDING, SLOPE TO BE GREATER THAN 1:40.
- (4) ACCESSIBLE RAHP W/ DETECTABLE WARNING ALONG ACCESSIBLE ROUTES (TYP.). SLOPE TO BE GREATER THAN 1:20 AND NO STEEPER THAN 1:12.
- (5) CONCRETE CURB. SEE CIVIL FOR LOCATIONS & DETAILS.
- (6) PAD MOUNTED TRANSFORMER WITH BOLLARDS. (COORDINATE W/ P.A., ANY OTHER LOCATIONS).
- (7) PROJECTED BUILDING OVERHANG, ABOVE (SHOWN DASHED).
- (8) GAS METER, COORDINATE WITH MECHANICAL.
- 9 REFUSE AND RECYCLING ENCLOSURE.
- ACCESSIBLE PARKING SPACES AND THEIR ACCESS AISLES SHALL BE I 1/2% (2% MAX.) SLOPE IN ALL DIRECTIONS.
- 11 PAINTED ACCESSIBLE PARKING SYMBOL TO MEET ALL GOVERNING CODES.
- (12) ACCESSIBLE PARKING SIGN AT ALL ACCESSIBLE STALLS.
- (13) CONFIRM SLOPE AT PAVEMENT WITH TRASH COMPANY.
- LIGHT POLE (TYPICAL). QUANTITY AND LOCATION OF POLES TO BE DETERMINED BY APPROVED PHOTOMETRICS.
- (15) BIKE RACK, DERO ROLLING RACK RR2H OR EQUAL. COLOR: TBD.
- $\begin{tabular}{ll} \hline \begin{tabular}{ll} \hline \end{tabular} \hline \end{tabular} \hline \end{tabular} \e$
- AUTOHATIC DOOR OFERATOR SHITCH ON SQUARE BOLLARD POST, MINMUM 5"X5".

 DOLLARD TO BE SHIFFACE-MOINTED TO OUTSIDE EDGE OF CONCRETE STOOP, BOLLARD TO BE FINISHED TO MATCH BUILDING EXTERIOR MATERIAL, SEE ENLARGED FLOOR PLAN AND DOOR HARDWARE.
- 18) PRELIMINARY MEDGAS LOCATION. COORDINATE WITH MEDICAL EQUIPMENT SUPPLIER.
- (19) RAINGARDEN. SEE CIVIL DRAWINGS FOR GRADING AND UTILITIES.

PARKING REQUIREMENTS:

PROPOSED BUILDING FOOTPRINT AREA = 6,760 SQ. FT. BUILDING AREA W MEZZANINE = 8,060 SQ. FT. PARKING REQUIRED = 1 PER 200 SQ. FT. = 40 STALLS PARKING PROVIDED =40 STALLS 20 STALLS ON SITE & 20 STALLS IN VICINITY CONFORMS TO VILLAGE OF ALLOUEZ ZONING 11.13 (K) SHALL RECEIVE ONE SPACE FOR EACH 200 SF OF FLOOR AREA

ADA PARKING SPACES: & VAN ACCESSIBLE = 2 SPACES PROVIDED

JE GREEN BAY
SS.WEBSTER AVENUE
OUEZ, WI 54301 SURGERY OF GREEN ARCHITECTURAL


PROJECT NO: 16-064 DRAWN BY: E.M. CHECKED BY: N.S.

SITE PLAN




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SURGERY CENTER OF GREEN BAY

PROJECT NO: 16-064 DRAWN BY: E.M. CHECKED BY: N.S.

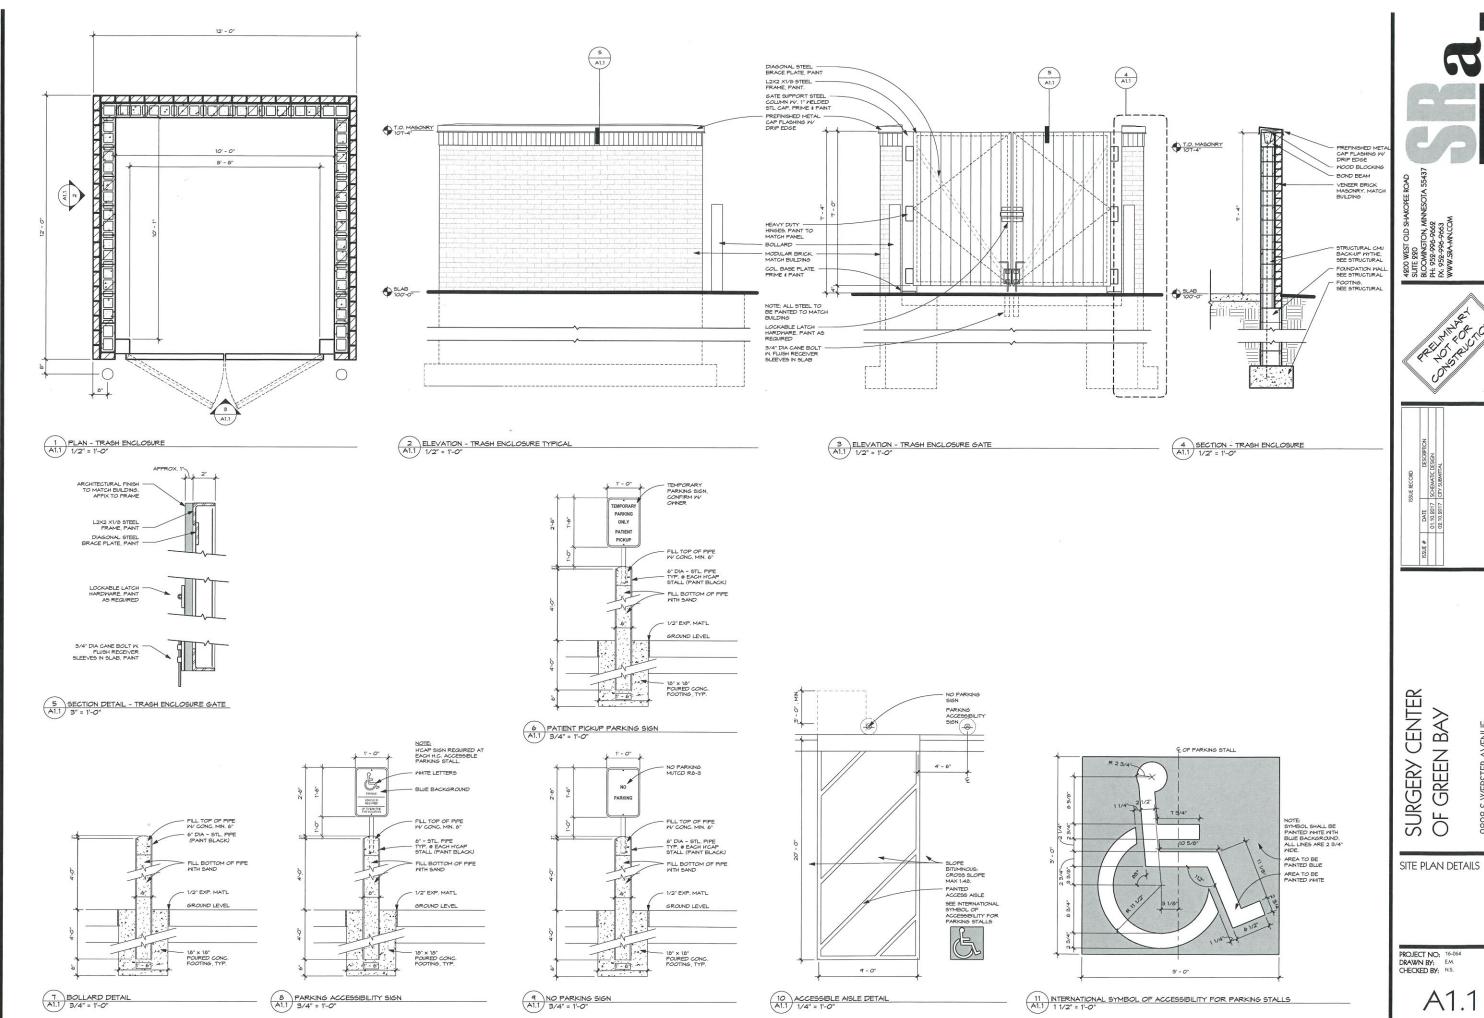



SURGERY CENTER OF GREEN BAY

PRELIMINARY PLANS

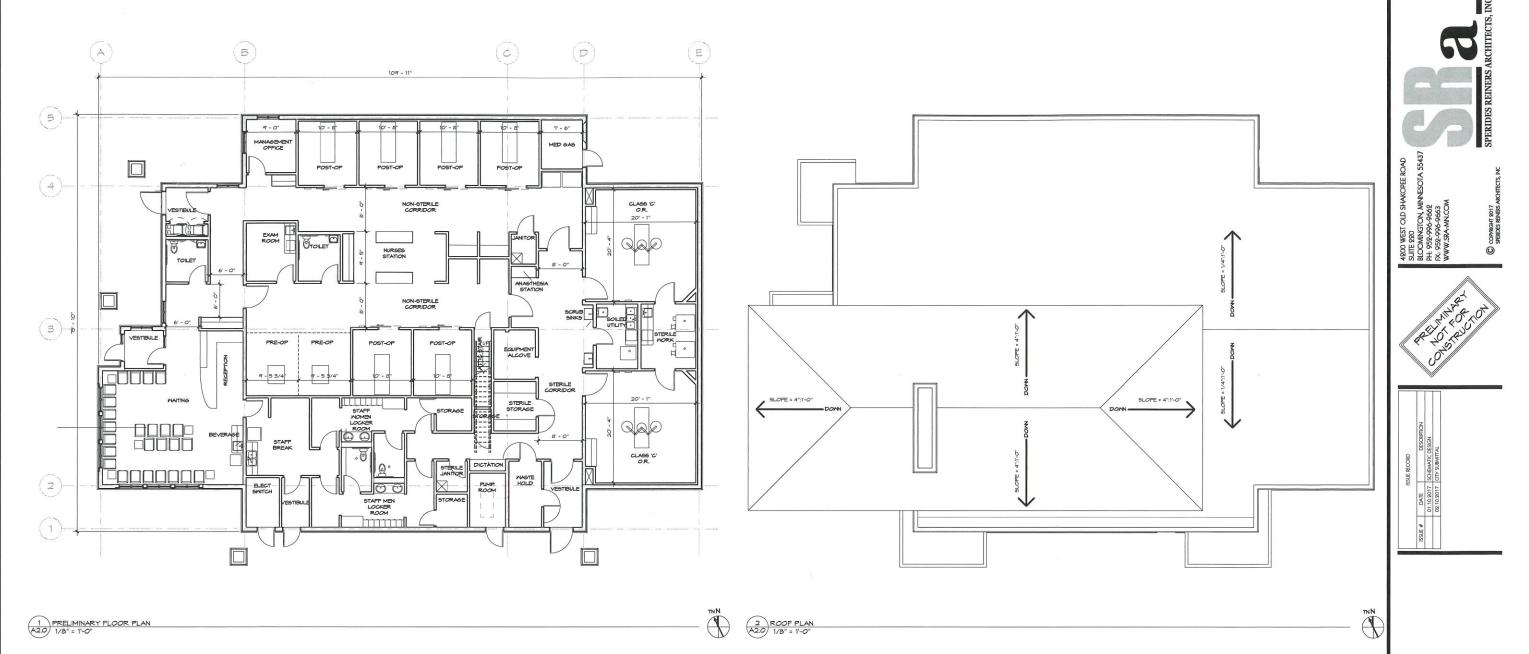
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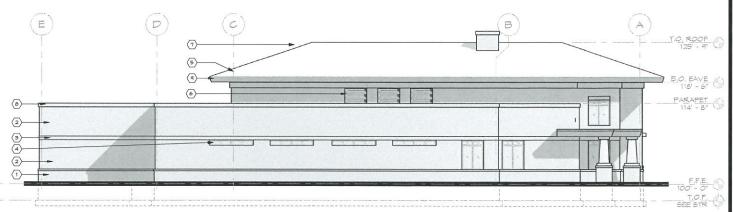
A2.0



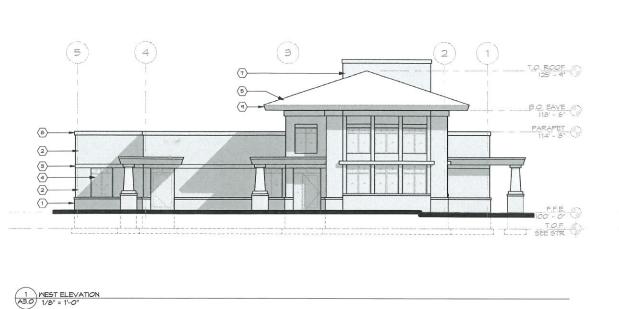

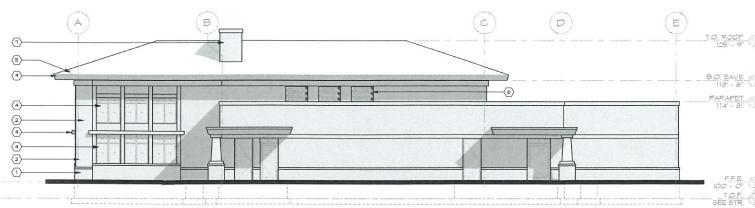2 SOUTH ELEVATION 1/8" = 1'-0"



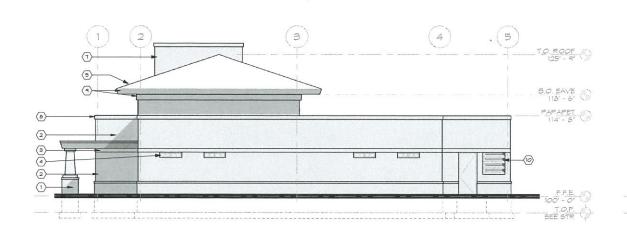

3 EAST ELEVATION A3.0 1/8" = 1'-0"

4 NORTH ELEVATION A3.0 1/8" = 1'-0"

EXTERIOR ELEVATION KEYNOTES

ALL MATERIAL TO COMPLY WITH ALLOUEZ ZONING CODE 11.29 (9A)

- (1) WALL BASE MATERIAL STONE. TYPE, COLOR, & PATTERN TO BE DETERMINED
- 2 EXTERIOR WALL FINISH #1, TYPE, COLOR, & PATTERN TO BE DETERMINED
- (3) EXTERIOR WALL FINISH #2.

 TYPE, COLOR, & PATTERN TO BE DETERMINED
- 4 ALUMINUM STOREFRONT SYSTEM. COLOR TO BE DETERMINED
- (5) ROOF SHINGLES, COLOR TO BE DETERMINED.
- (6) PREFINISHED METAL MECHANICAL LOUVERS.
- 7) MECHANICAL VENT STACK TO MATCH WALL BASE MATERIAL.
- B PREFINISHED METAL ROOF EDGE.
 COLOR TO BE DETERMINED
- PREFINISHED METAL FASCIA.
 COLOR TO BE DETERMINED
- (10) MEDGAS ACCESS PANEL.

Surgery Center Of Green Bay 2828 S WEBSTER AVENUE ALLOUEZ, WI 54301

PROJECT NO: 16-064 DRAWN BY: E.M. CHECKED BY: N.S.

ELEVATIONS

A3.0

Site Plan & Design Review – Staff Comments

Site:

2825 S Webster Avenue (Parcel AL-2127)

Development: Surgery Center of Green Bay

Developer:

Sperides Reiners Architects, Inc.

Ayres Associates

Zoning Department review:

Zoning di	strict	"C" Professional Office and Residence District				
Building use (allowed)		Medical Office/Clinic				
		Required	Provided	Notes		
Height		Lesser of 40' or 3 stories	Not provided			
Lot	Area	7,500SF	31,562SF			
	Frontage	100'	127.25′	Measurement based on Brown County aerials. Should be noted on plans.		
	Green space	20%	44%	iii		
Setback	Front	50'	72'	Calculation based on Brown County aerials. Should be noted on plans.		
	Side (inner)	10'	10'			
	Side (corner)	N/A	N/A			
	Rear	30'	60'			
Parking	Number	1.5/200SF + 1per employee on shift: 44	21 (on site)	Additional 28 stalls on adjoining parcel. Perpetual parking easement agreement between parcels should be established.		
	Size	10'x20'	Not provided	Stall size is allowed regardless if existing kept.		
	Bicycle	Bicycle parking should be provided	Standards met	Recommend a bicycle rack which accommodates a U-shaped lock and the ability to secure the bike frame and both wheels instead of proposed. Also maintain the rack out of the pedestrian zone.		
Access	Automobile	24' drive lanes with 90 degree parking	Not provided	Perpetual ingress/egress easement agreement between parcels should be provided. Lane width is allowed regardless if existing kept.		
	Pedestrian	ADA compliant sidewalks	Standards met	Sidewalk widths should be noted on plans. Pedestrian access from Webster Avenue or Broadview Drive is recommended.		
Architecture		Varied rooflines and other architectural designs that break-up the building mass	Standards met			
Exterior f	inishes	Brick, stone, glass, fiber cement siding, EFIS, stucco, wood siding	Not provided			
Lighting		Dark sky compliant, no light directed towards ROW, no more than 0.5FC at property line, must be shut off at 10p.m.	Standards met	There is a slight spillage of more than 0.5FC onto neighboring drive, which is acceptable. Staff recommends the full site lighting option.		
Sign	9	N/A	N/A	Location should be identified, but design is reviewed at time of sign permit. Sign should be shut off at 10p.m. with lights.		
Fences/Screening		No fences or berms are required, dumpster must be located at rear and be screened using same finishes as primary structure, mechanical equipment must be screened from street	Standards met, except for back-up generator	Back-up generator should be screened from view of the street to the greatest extent possible.		

^{**}All other zoning requirements for "C" Professional Office and Residence District stipulated in Chapter 475 of Village Ordinances should be met to the highest degree possible.

- Fire Department review:
 - The building will have a full NFPA 13 sprinkler system according to the architect.
 - Additional comments attached (Attachment 2B).
- Parks, Recreation, and Forestry Department review:
 - Comments attached (Attachment 2C).
- Public Works Department review:
 - Comments attached (Attachment 2D).
- Additional comments:
 - Location of construction access shared drive shall remain accessible and discussion should be considered for maintenance of shared roadway.

Date Reviewed:

February 22, 2017

Comments Submitted By:

Trevor Fuller, Village of Allouez Planning & Zoning Administrator



Fire Department

Fire Marshals Division Captain Joe Gabe

February 16th 2017,

Trevor Fuller-Planning and Zoning Administrator Village of Allouez 1900 Libal Street Green Bay, WI 54301-2453

RE: Site Plan Reviewer comments for the new Surgery Center of Green Bay located at 2825 South Webster Ave.

Dear Mr. Fuller,

Attached are the GBMFD requirements for the new Surgery Center of Green Bay located at 2825 South Webster Ave.

- GBFD requires that all exterior FDC (Fire Department Connections) and Standpipe connections are five inch Storz brand connections. If the FDC or Standpipe connection is higher than 30 inches above finished grade, then you will be required to install a thirty three down degree angle connection on the five in Storz connection to prevent hose kinking in the five inch supply line to the fire department connection. IFC 903.3.7.
- GBFD will require a Knox Box brand lock box at the Main entrance of the buildings. If
 the building contains a sprinkler control room that is accessed from the exterior a Knox
 box must also be placed adjacent to that door. The Knox Box brand locking boxes can be
 purchased by visiting the Knox Box website or calling (920) 448-3280 and requesting a
 Knox Box brand locking box packet. IFC #506.1 and 506.1.1.
- The parking lot and fire lane roads shall meet the minimum weight and turning radius for GBMFD apparatus (See Attached Specifications Sheets) IFC 503.2

If you have any questions please feel free to contact the Green Bay Fire Metro Marshal's Office at (920)448-3289.

Respectfully,

Captain Joe Gabe Fire Marshal's Office

Green Bay Fire Department

Phone-(920)448-3289

joega@greenbaywi.gov

LANDSCAPE PLAN

SCALE: 1" = 20'-0"

LANDSCAPE NOTES:

- . ALL PLANTING IN TURF AREAS SHALL BE ALL PLAYING IN THE AREAS SHALL BE IRRIGATED WITH AN UNDERGROUND IRRIGATION SYSTEM, NO WATER IS ALLOWED ON ANY PAYEMENT, PARKING, WALKWAY OR BUILDING. THE IRRIGATION CONTRACTOR IS TO DESIGN AND SUBMIT SHOP DRAWING OF IRRIGATION DESIGN AND CALCULATIONS TO ARCHITECT FOR REVIEW PRIOR TO INSTALLATION, IRRIGATION DESIGN IS TO MEET ALL CITY PLUMBING CODES AND REQUIREMENTS.
- 2. EDGE ALL SHRUB AND PERENNIAL BEDS WITH SIX (6) NCH WIDE BY 1/8" THICK BLACK POWDER COATED GALVANIZED STEEL LANDSCAPE EDGING. 3. PROVIDE FOUR (4) INCH MINIMUM DEPTH OF
- SHREDDED HARDWOOD BARK MULCH IN FOUR (4) FOOT DIAMETER RING AROUND ALL TREES LOCATED IN TURF AREAS, NO VINYL EDGING IS REQUIRED FOR TREES LOCATED IN SHRUB AREAS AND SEEDING AREAS.
- 4. PROVIDE FOUR (4) INCH MINIMUM DEPTH OF
- HARDWOOD BARK MULCH IN ALL PERENNIAL AREAS.
- 6. PROVIDE THREE (3) INCH DEPTH OF ONE AND - PROVIDE INCEE 137 INCH PIVER ROCK OVER BLACK UNLTHALF (1.5) INCH RIVER ROCK OVER BLACK LANDSCAFE FABRIC UNLESS OTHERWISE NOTED ON PLAN.

4200 WEST SUITE 220 BLOOMING PH: 952.99 FX: 952.99 WWW.SRAI

PRELIMINARY NOT FOR CONSTRUCTION

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LANDSCAPE

PLAN

- 7. LANDSCAPE CONTRACTOR IS RESPONSIBLE FOR FINISHED GRADING AND POSITIVE SURFACE DRAINAGE IN ALL LANDSCAPE AREAS LANDSCAPE CONTRACTOR MUST ENSURE THAT THE FINAL GRADES ARE MET AS SHOUN ON GRADING PLAN. IF ANY DISCREPANCIES ARE FOUND, IMMEDIATELY NOTIFY ARCHITECT FOR RESOLUTION
- 8. ALL PLANT MATERIALS ARE TO CONFORM WITH ALL PLANT TAILERIALS ARE TO COMPOST WITH STATE AND LOCAL CONSTRUCTION STANDARDS AND THE CURRENT ADDITION OF THE AMERICAN ASSOCIATION OF NURSERYMEN STANDARDS, ALL PLANT MATERIALS ARE TO BE HEALTHY, HARDY STOCK, AND PREE PROM ANY DISEASES, DAMAGE AND DISFIGURATION.
- A. CALANTITIES OF PLANTS LISTED ON THE PLAN ARE TO GOVERN ANY DISCREPANCY BETWEEN THE QUANTITIES SHOWN ON THE PLAN SCHEDULE AND PLAN, PLACE PLANTS IN PROPER SPACING FOLLOWING LAYOUT FIGURES I.O. SOD SHOUN ON LANDSCAFE PLAN TO BE
- NSTALLED BY LANDSCAPE CONTRACTOR SOD TO BE LAWN SOD, FREE OF WEEDS AND DISEASE.

 APPLY MINIMUM SIX (6) INCHES OF TOPSOIL AND THOROUGHLY FERTILIZE BEFORE LAYING SOD. LANDSCAPE CONTRACTOR TO MAINTAIN SODDED ARES IN HEALTHY CONDITION
- II. PLANTING SOIL FOR BACKFILLING TO BE TOPSOIL WITH 3 LB9, OF CONTERCIAL FERTILIZER AND ONE-FIFTH YARD OF FEAT HUMMUS PER CUBIC YARD. TOPSOIL TO BE SELECT TOPSOIL BORROW 2. SPREAD PLANTING SOIL AT MINIMUM EIGHTEEN
- (18) NCH DEEP IN ALL PERENNIAL BEDS PRIOR TO
- 3. FOLLOW LANDSCAPE DETAILS FOR ALL NSTALLATION, UNLESS OTHERWISE NOTED.
- 4. LANDSCAPE CONTRACTOR TO MAINTAIN PLANTS IN HEALTHY CONDITION THROUGHOUT GUARANTY PERIOD THE GUARANTY PERIOD IS THE GROWING SEASONS FROM DATE OF PROVISIONAL ACCEPTANCE UNTIL FINAL ACCEPTANCE.

LANDSCAPING:

VILLAGE OF ALLOUEZ ZONING CODE 11.29 (10-8) AT LEAST 20 PERCENT OF THE TOTAL LOT AREA

TOTAL PARCEL AREA: 31,562 SF 7,050 SF / 22% 10,752 SF / 34% 13,760 SF / 44% BUILDING AREA: PAVEMENT AREA GRASS & LANDSCAPED AREA:

REQUIRED LANDSCAPE 1. ONE (1) TREE PER DUELLING UNIT.

- (+1)
 ONE (1) TREE PER 1,000 SQLARE FEET OF GROSS
 FLOOR AREA, AND ANY FRACTION THEREOF, FOR
 NONRESIDENTIAL USES. (8,060 ÷ 1,000 = +8)
- ONE (1) TREE PER EVERY EIGHT (8) PARKING STALLS.
- (20 ÷ 8 = +2,5) (+2,5 FOR PARKING SOUTH OF SITE) ONE (I) STREET TREE FOR STREET FRONTAGES GREATER THAN 100 FEET. (127 LF FRONTAGE = 4)

(TOTAL 15 TREES REQUIRED)

PROVIDEDED LANDSCAPE

SHRUB PLANTING DETAIL

3) SHRUB I

TREE PLANTING DETAIL

5 TREES (43 EXISTING SOUTH OF SITE) EXISTING:

> PROJECT NO: 16-064 DRAWN BY: E.M.
> CHECKED BY: N.S.

Portestan O. T. STREET 100 Drage Orac 13 cm 60 Courses

C. So

2825 S.WEBSTER AVENU ALLOUEZ, WI 54301

Trevor Fuller

From:

Craig Berndt

Sent:

Thursday, February 16, 2017 3:53 PM

To:

SchuhC@ayresassociates.com

Cc:

Trevor Fuller

Subject:

Surgery Center of GB Stormwater

Hi Craig-

This is a follow-up to our telephone conversation of yesterday regarding stormwater requirements for the Surgery Center project.

This project will require a stormwater permit and engineering submittal for the project. The village post-construction stormwater ordinance, for a site of less than 20,000 ft2 disturbed area, requires stormwater treatment the same as a larger site but we do not impose a hard numerical discharge limit to allow some flexibility. Treatment methods are the same as a larger project, so consider the type and extent of treatment needed and include this in your stormwater application.

This project will discharge stormwater to the storm sewer that ultimately discharges to the village Heritage Hill stormwater pond. Treatment at this pond is expected to be removals of 69% TSS and 48% TP. You may elect to purchase treatment capacity at this pond rather than construct full treatment at on the project site. The fee in lieu of treatment cost is \$18 per ton of TSS applied as a one-time charge based on the annual discharge amount. We would have to determine the TP treatment cost.

The Fox River TMDL treatment requirements are removals of 72% TSS and TP of 42% removal. Your discharge, from the project site plus the pond (if you purchase capacity) must meet this requirement. If you do not purchase treatment capacity then the site discharge must meet this requirement. The amount of treatment you need to provide is not very much, but we do still require the flow equalization criteria.

Please let me know when you plan to submit the application and stormwater information. We will proceed with the planning commission approval process, but the building permit will not be issued until the stormwater permit has been issued. On complex projects it requires some time to review the stormwater permit application and engineering report, but this project is simpler so this should be a short review.

Please let me know if you have questions. Thanks, Craig

Craig L. Berndt, P.E.
Director, Public Works
Village of Allouez
1900 Libal Street
Green Bay, WI 54301
(920) 448-2800
Craig@villageofallouez.com



3/2/2017

Trevor FullerVillage of Allouez
Planning and Zoning Administrator

Re:

Letter of clarification regarding Cross Access

Surgery Center of Green Bay

SRa Comm # 16-064

Dear Trevor:

Thank you for the opportunity to work with the Village of Allouez on the Surgery Center of Green Bay project.

On behalf of our Client EV Acquisitions, LLC we would like to inform you that we are prepared to have an easement created to allow for cross access and parking access for the adjacent parcel to our building site. This easement will be created by EV Acquisitions attorney and land surveyors and submitted prior to the submittal for the building permit.

Thank you very much for your consideration.

Sincerely,

Sperides Reiners Architects, Inc.

Nicholas S. Sperides, AIA, NCARB Principal

CC:. - Eric VanMiller Craig Schuh